

CEANOTHUS 'CENTENNIAL'

FESTUCA 'ELIJAH BLUE'

EPILOBIUM CANUM

- MYO PIN - MYOPORUM P. 'PINK'

CEANOTHUS

CAL. FUSCHIA

BLUE FESCUE

PINK MYOPORUM

NUMBER

PROJECT

NUMBER:

24-057.01

- 5' O.C. SPACING


- 3' O.C. SPACING


- 6' O.C. SPACING

12" O.C. SPACING

I GAL

ARCHITECTURE

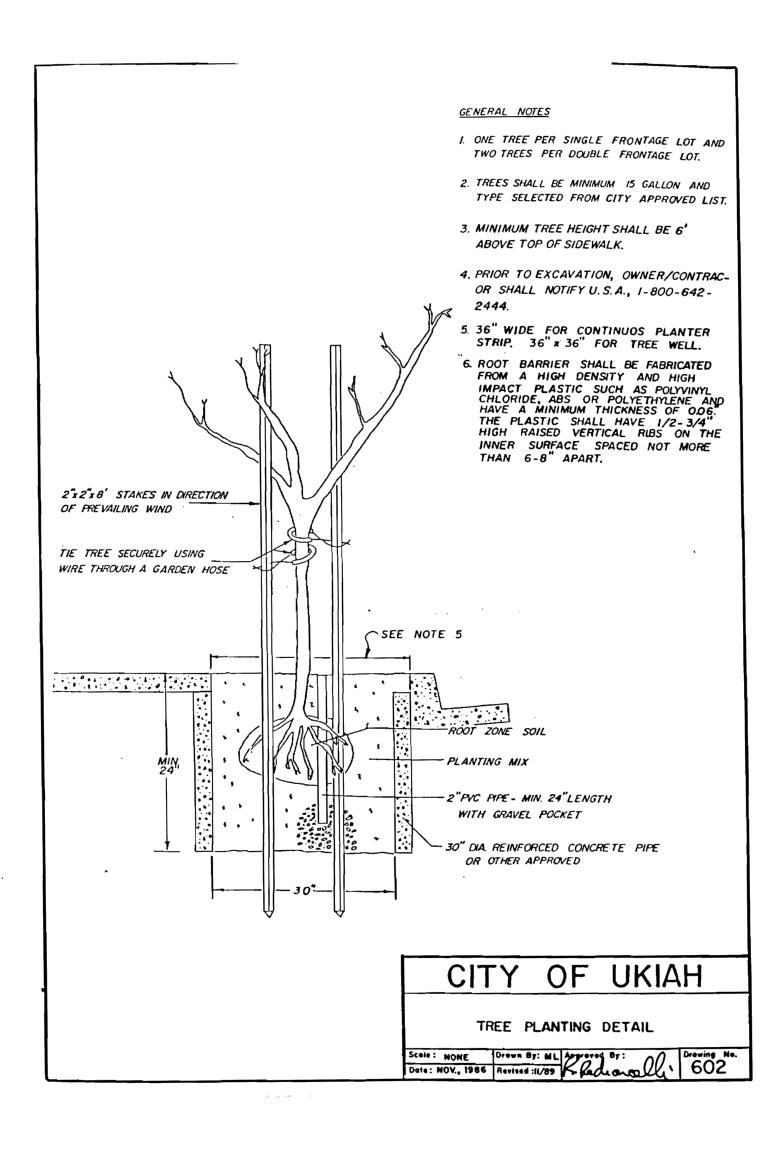

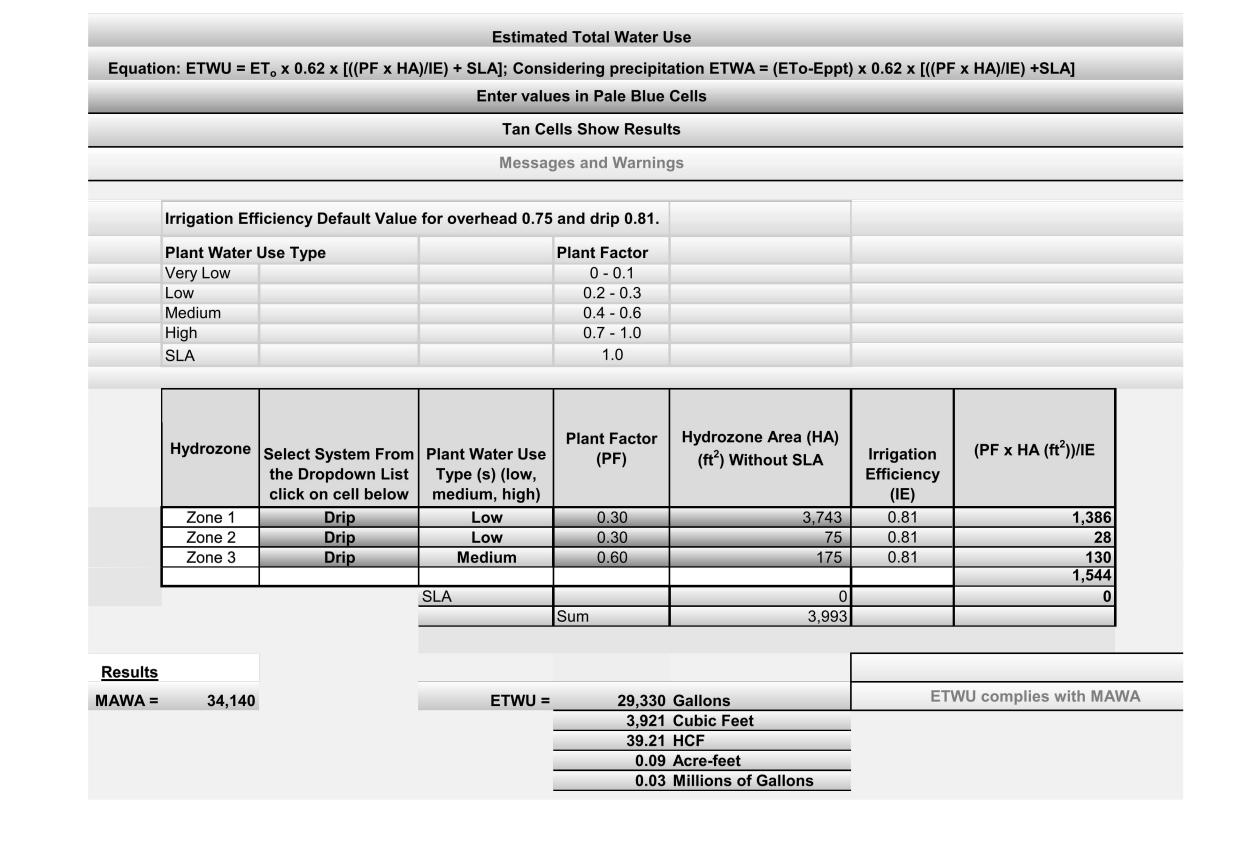

10/04/2024

MWELO STATEMENT

"I HAVE COMPLIED WITH THE CRITERIA OF THE ORDINANCE AND APPLIED THEM FOR THE EFFICIENT USE OF WATER IN THE IRRIGATION PLAN"

UM.

MICHAEL A. COOK
REGISTERED LANDSCAPE ARCHITECT #5123

#### IRRIGATION NOTES

- I. LANDSCAPE CONTRACTOR (C-27 LICENSE) SHALL BID AND INSTALL IRRIGATION PER THESE PLANS AND SPECIFICATIONS, UNLESS GIVEN FURTHER WRITTEN INSTRUCTIONS, OR REVISED PLANS PER OWNER OR LANDSCAPE ARCHITECT. WORK INCLUDES, BUT IS NOT LIMITED TO ALL LABOR, COVERED LIABILITY INSURANCE, WORKMAN'S COMPENSATIONS, EQUIPMENT AND MATERIALS NECESSARY TO FURNISH, INSTALL AND TEST IRRIGATION SYSTEM, AS SHOWN ON THE DRAWINGS AND SPECIFIED HEREIN.
- 2. COORDINATE A MINIMUM OF (2) FIELD OBSERVATIONS WITH LANDSCAPE ARCHITECT AND CALL TO PROVIDE 48 HOUR NOTICE:

  A. VERIFY FLAGGED HEAD AND CHALKED MAINLINE LAYOUT PRIOR TO TRENCHING OPERATIONS. ADJUST LAYOUT AS
  - DIRECTED BY LANDSCAPE ARCHITECT.

    B. OBSERVE COMPLETE PLUMBING SYSTEM AND PRESSURE TEST ALL MAINLINE & LATERALS PRIOR TO ANY BACKFILLING
- 3. CONTRACTOR SHALL PROVIDE SUBMITTALS/CUT SHEETS TO LANDSCAPE ARCHITECT OF ALL IRRIGATION MATERIALS INCLUDING, BUT NOT LIMITED TO CONTROLLER, CONTROL WIRE, MAIN LINE PVC, VALVES, PRESSURE REDUCER, ETC. CONTRACTOR SHALL FURNISH TO OWNER KEYS TO CONTROLLER, QUICK COUPLER AND ANY SPECIAL TOOLS REQUIRED FOR MAINTENANCE OF ALL IRRIGATION COMPONENTS.
- 4. MANUFACTURERS DIRECTIONS AND DETAILED DRAWINGS SHALL BE FOLLOWED IN ALL CASES WHERE THE MANUFACTURERS OF
- COMPONENTS, USED IN THIS CONTRACT, COVER POINTS NOT SHOWN ON DRAWINGS AND SPECIFICATIONS.

  A. CONTRACTOR SHALL KEEP DETAILED REDLINE PLAN RECORDING INSTALLATION OF IRRIGATION SYSTEM AS IT PROGRESSES. RECORD PLAN SHALL BE DRAFTED ONTO DRAWINGS PROVIDED BY LANDSCAPE ARCHITECT, INTO AS-BUILT DRAWINGS SHOWING LOCATIONS OF POINT OF CONNECTION, LATERALS, MAIN LINES, QUICK COUPLERS, VALVES, HEADS, WIRING, ETC., FOR APPROVAL BY LANDSCAPE ARCHITECT. FOLLOWING APPROVAL, AS-BUILTS SHALL BE REDUCED TO IIXI7 SIZE, COLOR CODED BY STATION, AND LAMINATED IN 6 MIL. PLASTIC. 3 REQUIRED FOR EACH CONTROLLER.
- B. THREE LAMINATED DETAILED IRRIGATION SCHEDULES SHOWING STATION PROGRAMMING AND RUN TIMES SHALL BE PROVIDED FOR EACH CONTROLLER AND APPROVED BY LANDSCAPE ARCHITECT; ONE WARM SEASON, ONE COOL SEASON AND ONE FOR ESTABLISHMENT PERIOD. EACH SCHEDULE SHALL BE ACCOMPANIED BY REDUCED "AS-BUILT" PLAN PERMANENTLY MOUNTED IN OR NEAR CONTROLLER. THESE SHALL BE SUBMITTED PRIOR TO ACCEPTANCE TO WORK AND AS A CONDITION OF COMMENCEMENT OF MAINTENANCE PERIOD.
- 5. ALL IRRIGATION EQUIPMENT TO BE INSTALLED PER CITY, COUNTY AND STATE STANDARDS. THE CONTRACTOR SHALL OBTAIN AND PAY FOR ANY AND ALL PERMITS AND INSPECTIONS AS REQUIRED. THE MATERIAL AND WORK SHALL CONFORM TO ALL APPLICABLE PROVISIONS OF THE LATEST ADDITIONS OF THE UNIFORM PLUMBING CODE AND THE NATIONAL ELECTRIC CODE. CONTRACTOR SHALL FAMILIARIZE HIMSELF/HERSELF WITH ALL STATE AND LOCAL LAWS, CODES, ORDINANCES, RESTRICTIONS BEFORE BEGINNING INSTALLATION.
- 6. CONTRACTOR SHALL VERIFY GALLONS PER MINUTE (G.P.M.) AT POINT OF CONNECTION DOWNSTREAM OF BACKFLOW DEVICE TO BE A MINIMUM OF 60 G.P.M. AND 30 P.S.I. CONTRACTOR SHALL NOTIFY LANDSCAPE ARCHITECT OF ANY DISCREPANCIES PRIOR TO COMMENCING WORK, FAILURE TO DO SO WILL MAKE THE CONTRACTOR LIABLE FOR ALL NECESSARY CHANGES.
- 7. TEST ALL PRESSURE LINES PRIOR TO BACK FILLING, UNDER STATIC PRESSURE OF 150 PSI FOR A PERIOD OF 2 HOURS. IF LEAKS DEVELOP, REPAIR SYSTEM AND REPEAT TEST UNTIL PRESSURE IS HELD.
- 8. ALL 120V. ELECTRIC POWER SUPPLY FOR IRRIGATION CONTROLLER SHALL BE PROVIDED AND CONNECTED TO CONTROLLER BY A LICENSED ELECTRICIAN. LANDSCAPE CONTRACTOR SHALL MAKE HARDWIRE CONNECTION FOR ALL CONTROL WIRES. CONTRACTOR SHALL INSTALL CONTROL WIRES THAT:

- A. CONNECTIONS BETWEEN THE CONTROLLER AND THE REMOTE CONTROL VALVES SHALL BE MADE CONTINUOUS (NO SPLICES) WITH DIRECT BURIAL COPPER WIRE 14 GA. AWG U.F. 600 VOLT. TAPE WIRES TO THE MAINLINE AT 10 FOOT
- INTERVALS, EXCEPT WHERE INDEPENDENTLY SLEEVED UNDER PAVING.

  B. PROVIDE THREE CONTINUOUS LOOP WIRES FROM THE CONTROLLER TO EACH VALVE WITH 9' LOOP, LABEL IN VALVE BOX. PROVIDE SEPARATE COLOR WIRES FOR CONTROL, COMMON AND EXTRA LOOP WIRES. CONTROL SHALL BE RED, COMMON SHALL BE WHITE AND EXTRAS SHALL BE BLACK/YELLOW.

C. AN EXPANSION CURL SHALL BE PROVIDED WITHIN (3) FEET OF EACH WIRE CONNECTION IN VALVE BOX. EXPANSION CURLS

- SHALL BE 18 INCHES IN LENGTH AT EACH SPLICE CONNECTION AND AT EACH CONTROL VALVE, SO THAT IN CASE OF REPAIR THE VALVE BONNET CAN BE BROUGHT TO THE SURFACE WITHOUT DISCONNECTION OF THE CONTROL WIRES.
- D. ALL SPLICES SHALL BE MADE WATERPROOF WITH RAINBIRD SNAP-TIE WIRE CONNECTIONS OR APPROVED EQUAL.
- 9. THESE DRAWINGS INCLUDE A DIAGRAMMATIC DISPLAY THAT SHOWS:
  A. BEFORE PROCEEDING WITH ANY WORK, CONTRACTOR SHALL CHECK AND VERIFY ALL DIMENSIONS AND QUANTITIES;
  CONTACT AND INFORM THE LANDSCAPE ARCHITECT OF ANY DISCREPANCIES BETWEEN DRAWINGS AND ACTUAL CONDITION
  - IMMEDIATELY.

    B. LAYOUT OF PIPING, VALVES, AND HEADS IS DIAGRAMMATIC. THERE MAY BE FIELD ADJUSTED FOR EASE OF INSTALLATION, COMMON TRENCHING, AND OPTIMUM COVERAGE. OBTAIN WRITTEN APPROVAL FOR CHANGES PRIOR TO CONSTRUCTION.
  - OFFSET, FITTINGS, SLEEVES, ETC. ARE NOT INDICATED DUE TO SCALE OF DRAWINGS, AND ARE TO BE FURNISHED AS REQUIRED.

    D. CONTRACTOR SHALL ASSUME ALL RESPONSIBILITY FOR WORK INSTALLED IN AREA WHERE WORK HAS BEEN MODIFIED

C. DRIP SYMBOL IS SCHEMATIC, VERIFY PLANT QUALITIES FOR EXACT NUMBER OF EMITTERS AND LENGTH OF PIPE. ALL

- WITHOUT WRITTEN APPROVAL.E. PIPE SIZES ON PLANS ARE MINIMUM ALLOWABLE.
- 10. FINAL LOCATION OF BACKFLOW PREVENTION DEVICE SHALL BE APPROVED BY LANDSCAPE ARCHITECT.
- II. THE DRIP PORTION OF THE SYSTEM SHALL BE AUTOMATICALLY OPERATED AND CAPABLE OF OPERATING THE SYSTEM FROM 1/2 HOUR TO SEVERAL HOURS PER DAY AND PER SETTING, AND HAVE AN AUTOMATIC RAIN SHUTOFF UNIT. THE SYSTEM SHALL MEET THE FOLLOWING BASIC PARAMETERS:

  A. FROM THE VALVE ASSEMBLY, A 3/4 INCH SCH 40 PVC PIPE SHALL BE BROUGHT TO A 3/4 INCH PVC TEE. ALL STATIONS
  - SPEED OF 5 FEET PER SECOND.

    B. A 5/8" A/R PVC HOSE SHALL EXTEND FROM EACH SIDE OF THE PVC TEE. THE FLOW IN EACH OF THESE 5/8" LINES SHALL NOT EXCEED I80 GALLONS PER HOUR. A TORO NGE PC EMITTER (OR APPROVED EQUAL) SHALL BE INSTALLED INTO THIS HOSE PER THESE QUANTITIES: TWO I/2 GALLON PER HOUR SINGLE OUTLET EMITTERS SHALL BE PLACED AT THE BASE OF EACH I GALLON CONTAINER, TWO I GALLON PER HOUR EMITTERS SHALL BE PLACED AT THE BASE OF EACH 5 GALLON CONTAINER. CAP ALL LINE ENDS WITH A BALL VALVE SO THEY MAY BE FLUSHED. USE A KB INLINE CHECK VALVE WHERE REQUIRED FOR LOW-HEAD DRAINAGE WHERE ELEVATION DIFFERENTIAL BETWEEN HEADS MAY CAUSE RUN OFF.

SHOULD BE CENTER-LOADED WHEREVER POSSIBLE, AND AT NO TIME SHALL THE WATER FLOW IN ANY PIPE EXCEED A

- C. THE SYSTEM SHALL BE DESIGNED ACCORDING TO TORO RECOMMENDATIONS AND FOR A WORKING PRESSURE OF 25 PSI.

  12. AVOID CUTTING EXISTING ROOTS GREATER THAN I" DIAMETER, TUNNEL UNDER ROOT WITHOUT DAMAGING CAMBIUM LAYER OF BARK. ALL TRENCHING WITHIN THE DRIPLINE OF EXISTING TREES SHALL BE DONE BY HAND, VERIFY PIPE ROUTE WITH LANDSCAPE
- 13. USE SCH 40 PVC AT DRIVEWAY/ROAD CROSSING WITH 24" OF COVER. ALL SLEEVES TO BE TWICE DIAMETER OF REQUIRED PIPE AND

- EXTEND 12" BEYOND PAVING EDGE. SLEEVE EACH PIPE SEPARATELY AND PROVIDE SEPARATE SLEEVE FOR CONTROL WIRES.
- 14. THE TRENCHES SHALL NOT BE BACKFILLED UNTIL ALL REQUIRED TESTS ARE PERFORMED. BACKFILL SHALL BE WATER SETTLED OR MECHANICALLY COMPACTED IN LANDSCAPED AREAS TO A DRY DENSITY EQUAL TO ADJACENT UNDISTURBED AREAS. CONTRACTOR WILL INSTALL 3" WIDE DETECTABLE TAPE (#3 DTP, AS MANUFACTURED BY T. CHRISTY). TAPE SHALL BE INSTALLED 6" ABOVE THE IRRIGATION MAINLINE AND BE LABELED "CAUTION WATER LINE BURIED BELOW". INSTALL ABOVE ALL WATER MAIN LINES. BACKFILLING SHALL CONFORM TO ADJACENT GRADES WITHOUT DIPS, SUNKEN AREAS, HUMPS OR OTHER SURFACES IRREGULARITIES. IF SETTLEMENT OCCURS AND SUBSEQUENT ADJUSTMENTS ARE NECESSARY, THE CONTRACTOR SHALL MAKE ALL REQUIRED ADJUSTMENTS WITHOUT COST TO THE OWNER.
- 15. THE CONTRACTOR SHALL GUARANTEE THE IRRIGATION SYSTEM FOR A PERIOD OF 12 MONTHS. THE SYSTEM SHALL BE FREE FROM DEFECTS IN MATERIALS AND WORKMANSHIP AND THE CONTRACTOR SHALL REPAIR OR REPLACE ANY DEFECTS AND REPAIR ANY DAMAGE CAUSED BY DEFECTS FOR THE ABOVE MENTIONED TIME PERIOD AT NO COST TO THE OWNER. SUCH REPAIRS OR REPLACEMENTS SHALL BE COMPLETED WITHIN A 48 HOUR PERIOD AND IMMEDIATELY IF IT IS A SAFETY ISSUE.
- 16. CLEANUP SHALL BE MADE AS EACH PORTION OF WORK PROGRESSES. ALL PAVING AND WALKS SHALL BE BROOMED OR WASHED DOWN AND ANY DAMAGE SUSTAINED TO THE WORK OF OTHERS SHALL BE REPAIRED TO ORIGINAL CONDITIONS ACCEPTABLE TO THE OWNER


PLA LAN ARC

PLANNING+ LANDSCAPE IRRIGATION + MWELO CALCULATIONS CONCEPTUAL LANDSCAPE PLAN FINANCIAL INSTITUTION

414 EAST PERKINS STREET, UKIAH, CALIFORNIA 95482

ARCHITECT PRIOR TO TRENCHING.

DATE: 10/04/2024
SHEET
NUMBER: L-2 0 F 2
PROJECT
NUMBER: 24-057.01

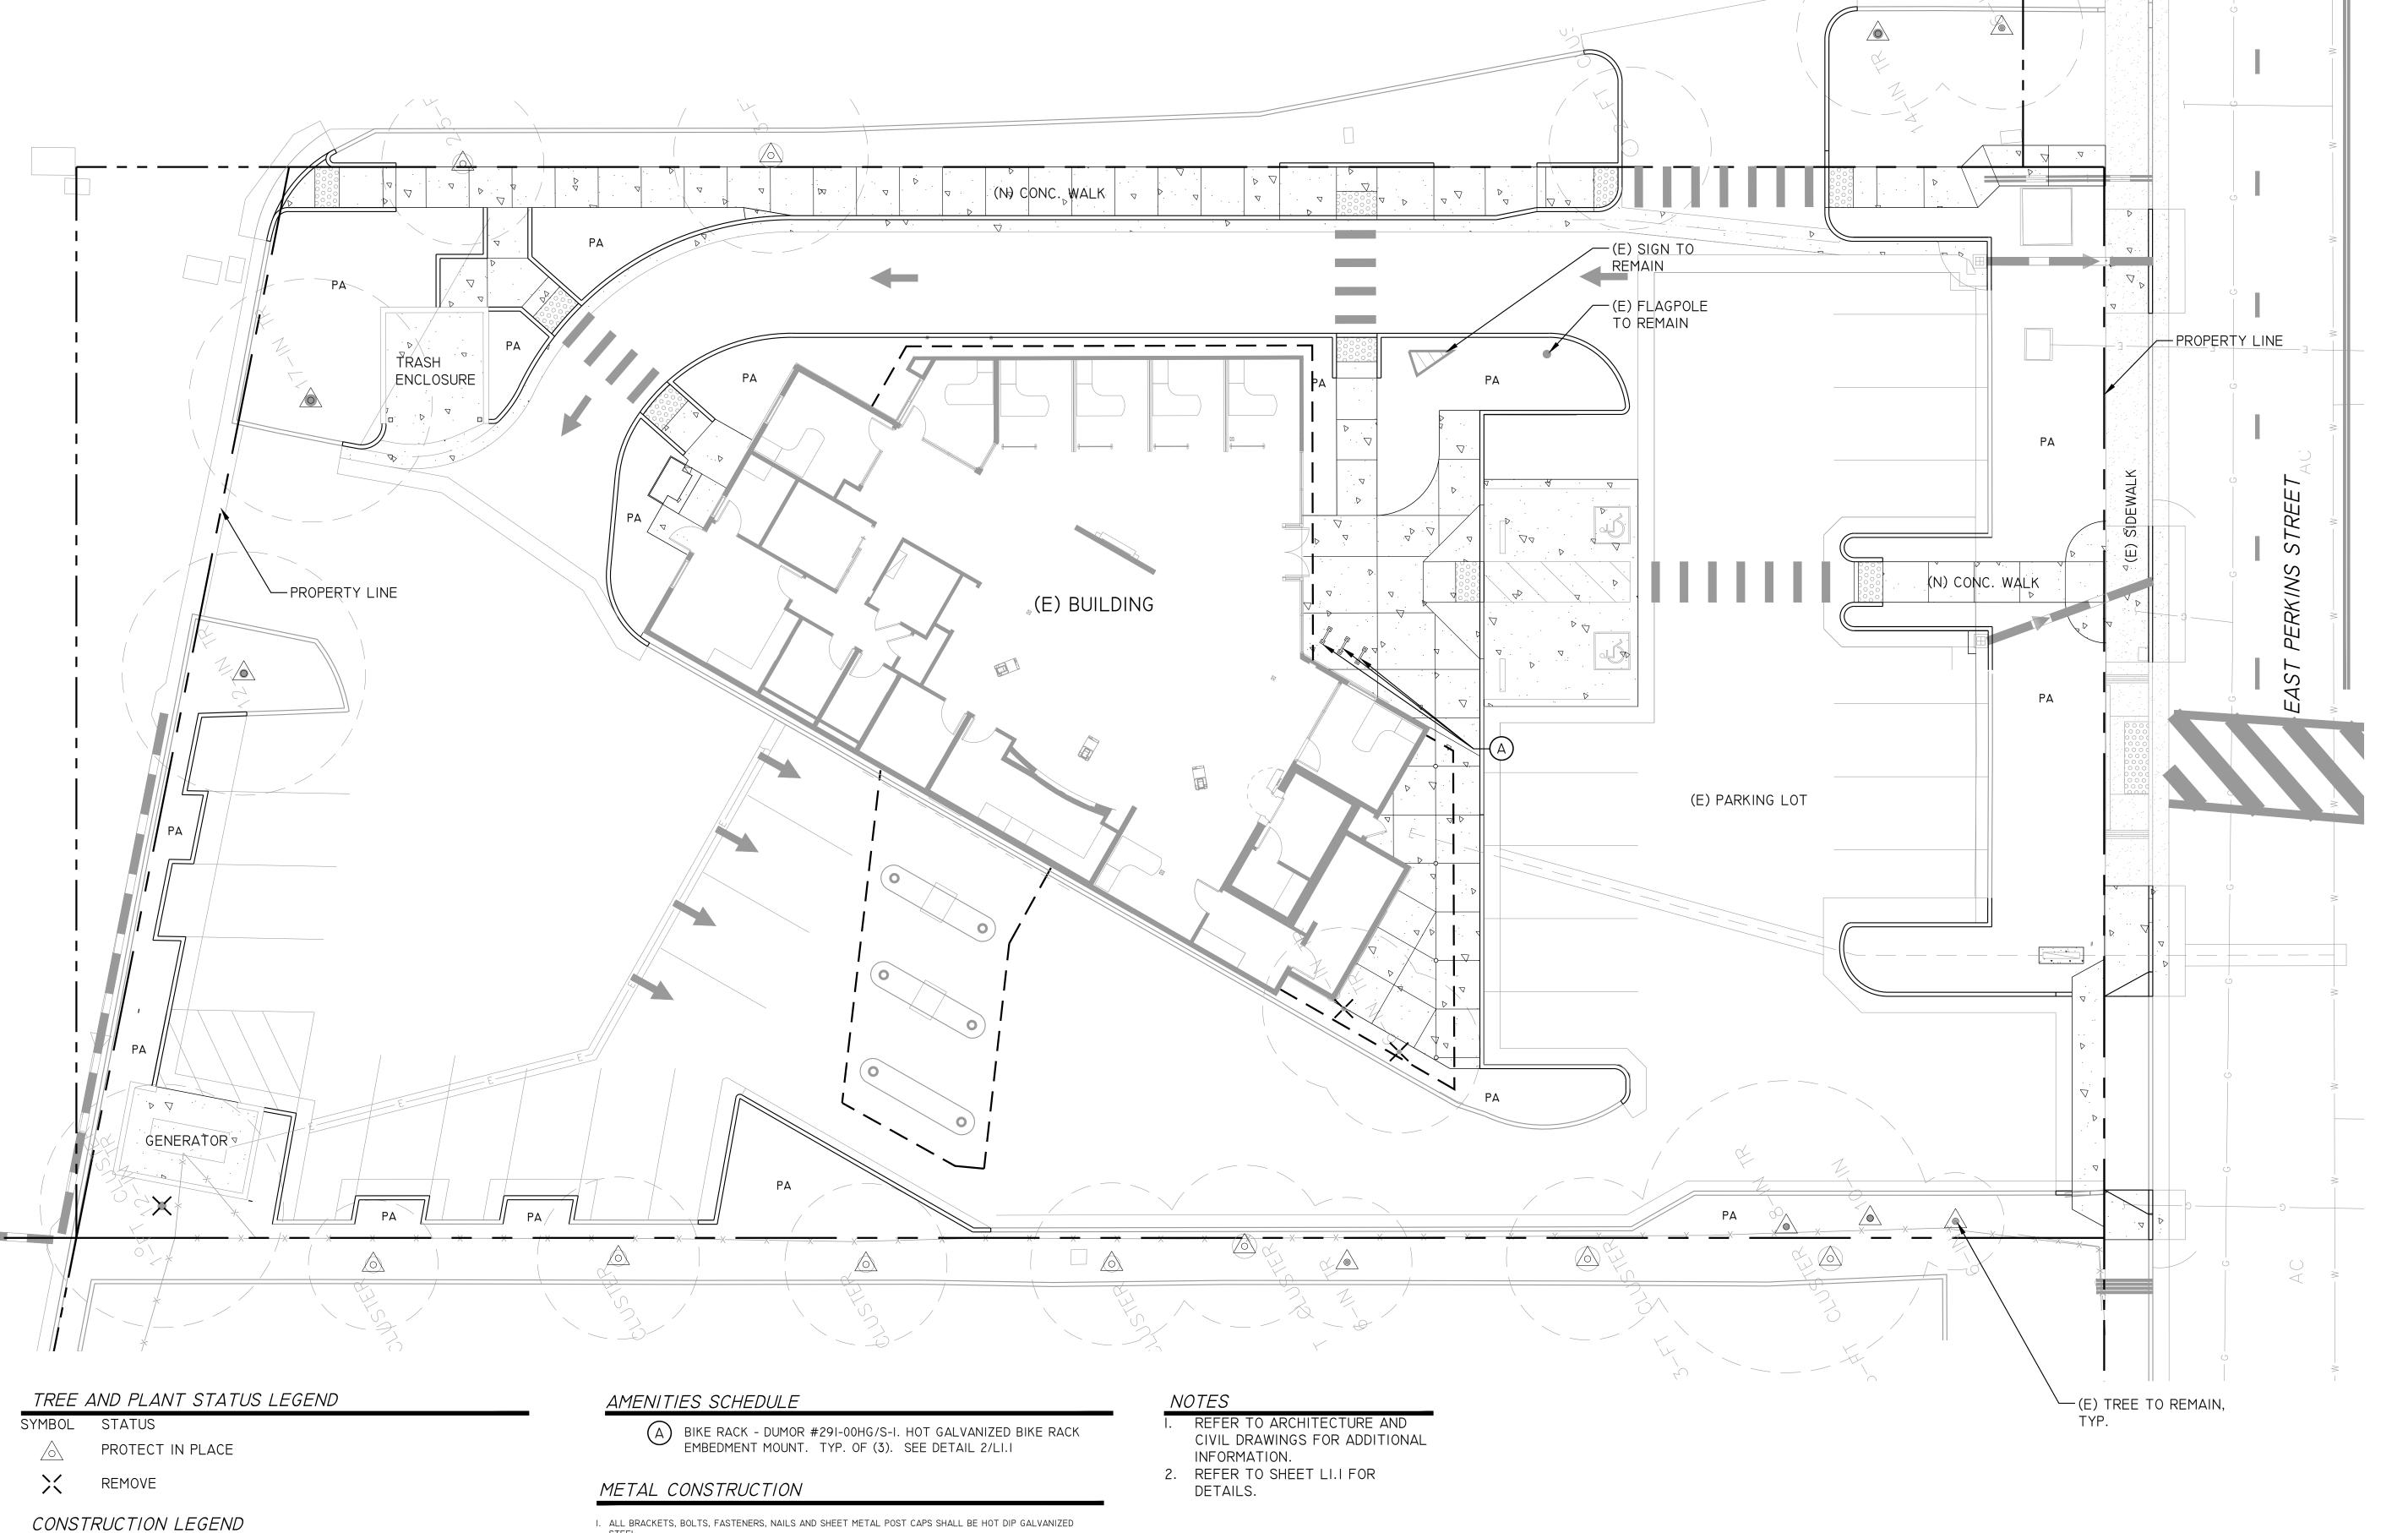

Signature 11 / 30 / 2026 Renewal Date 03 / 11 / 2025 Michael A. Cook



PLA 5123 Exp. 11/30/2026

PLANNING+ LANDSCAPE

ARCHITECTURE 1506 4TH STREET SANTA ROSA, CALIFORNIA 95404 707.852.0500 WWW.INTEGRAPLA.COM INTEGRA IS NOT RESPONSIBLE FOR THE ACCURACY OR COMPLETENESS OF REPRODUCTIONS OF THIS DOCUMENT GENERATED BY OTHERS FROM ELECTRONIC MEDIA.

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<u>PROJECT:</u>

REDWOOD CREDIT 414 EAST PERKINS STREET UKIAH, CALIFORNIA, 95482 APN #002-200-32

CLIENT: AXIA ARCHITECTS

540 MENDOCINO AVENUE SANTA ROSA, CALIFORNIA, 95401

SHEET DESCRIPTION: SITE PLAN

REVISIONS:

03/11/2025 DATE: SCALE: |"=|0'-0" DRAWN BY: MG

SHEET L1.0 of 7 NUMBER : PROJECT NUMBER: 24-057.02

MAC

CHECKED BY:


- ✓ ALIGN
- CENTER LINE
- PA PLANTING AREA R RADIUS
- TYP. TYPICAL
- | DETAIL REFERENCE LI.0 SHEET NUMBER
- | REFER TO MATERIAL SCHEDULE
- A REFER TO AMENITIES SCHEDULE

- 2. PRE-DRILL ANY HOLES FOR LAG BOLTS ¼"Ø OR GREATER BY ⅙" LESS THAN FASTENER SIZE. PRE-DRILL HOLES FOR THROUGH BOLTS ¼"Ø OR GREATER BY ⅙" LARGER THAN FASTENER SIZE TO REDUCE FUTURE CHECKING.
  3. USE EPOXY BASED EXTERIOR ADHESIVE FOR ALL PLUGS, SAND UNTIL FLUSH WITH MEMBER.
- 4. USE GALVANIZED STEEL FOR ALL HARDWARE (UNLESS NOTED OTHERWISE).
- 5. PRE-DRILL & FIT ALL FASTENER PENETRATIONS AND WELDED CONNECTIONS PRIOR TO STAINING.
- 6. CONTRACTOR SHALL COORDINATE LAYOUT OF ALL UTILITIES & ROUTES FOR ELECTRICAL THROUGH FOOTINGS & INSIDE POST TO FINAL DESTINATION.


  7. FIELD VERIFIED 'AS-BUILT' DIMENSIONS AS REQUIRED. PROVIDE SHOP DRAWINGS FOR ANY CHANGES FROM



GRAPHIC SCALE (IN FEET) I INCH = 10 FT

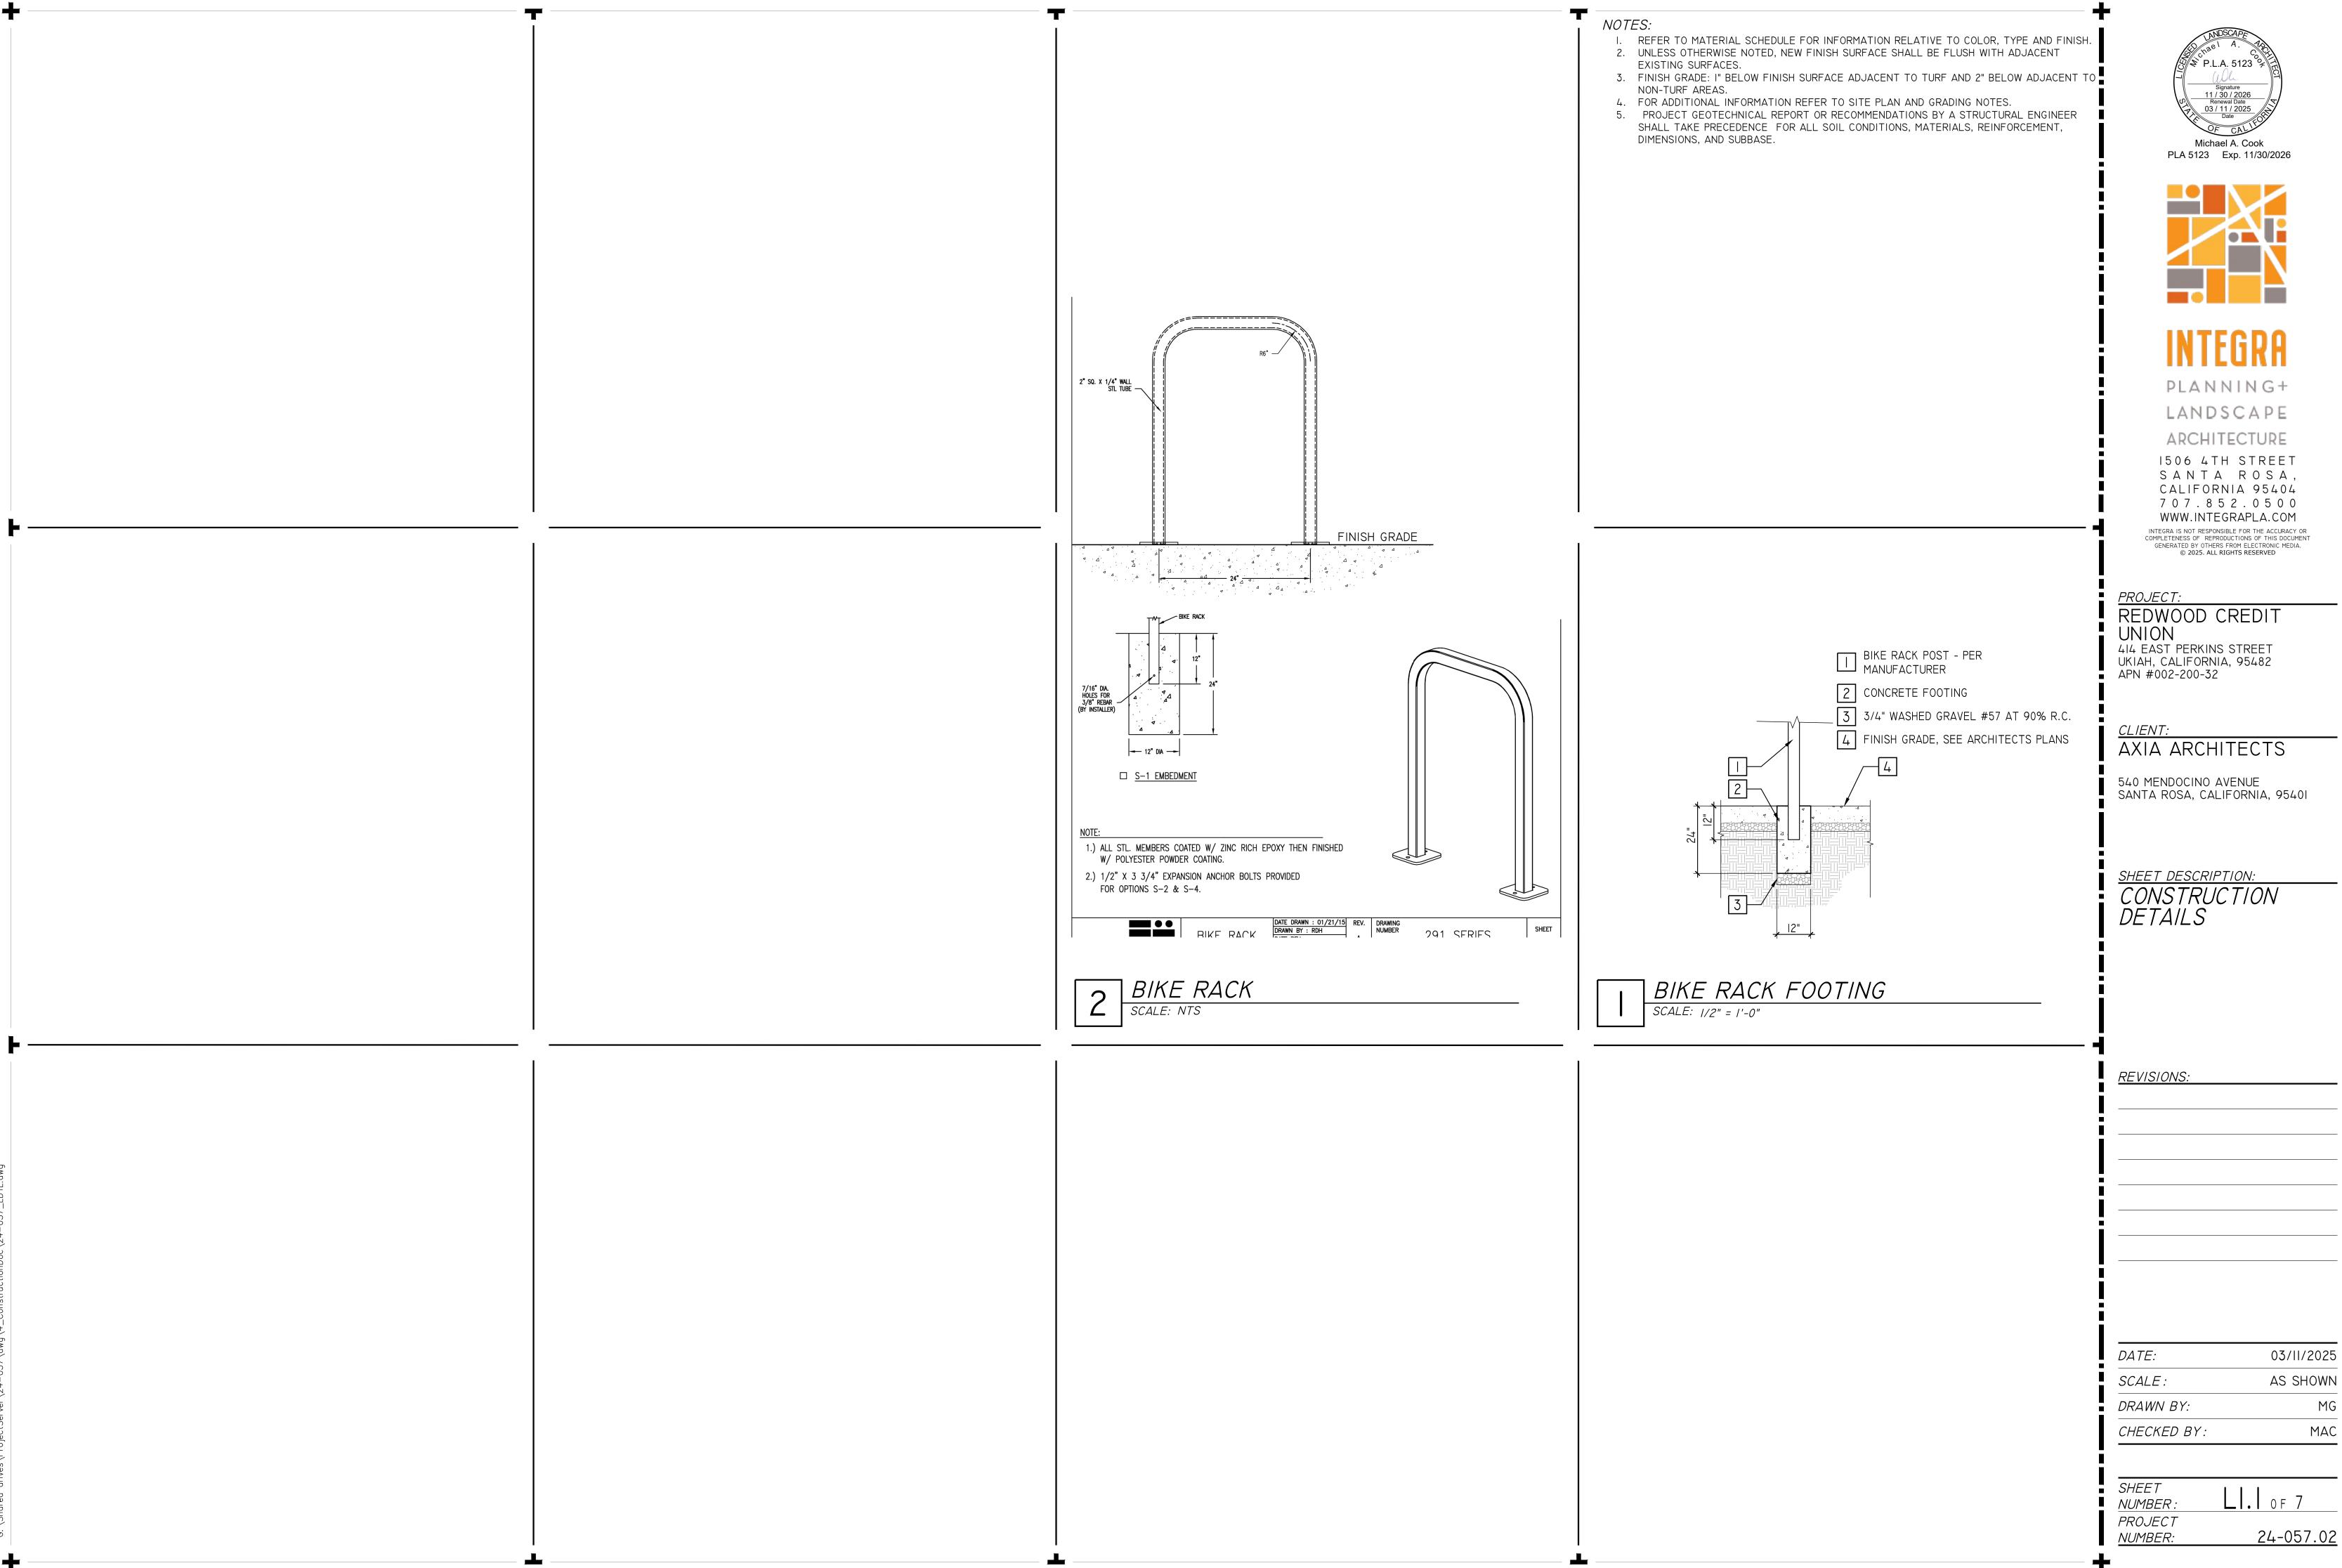

G: \Shared drives\ProjectServer\24-057\dwg\4\_ConstructionDoc\24-057

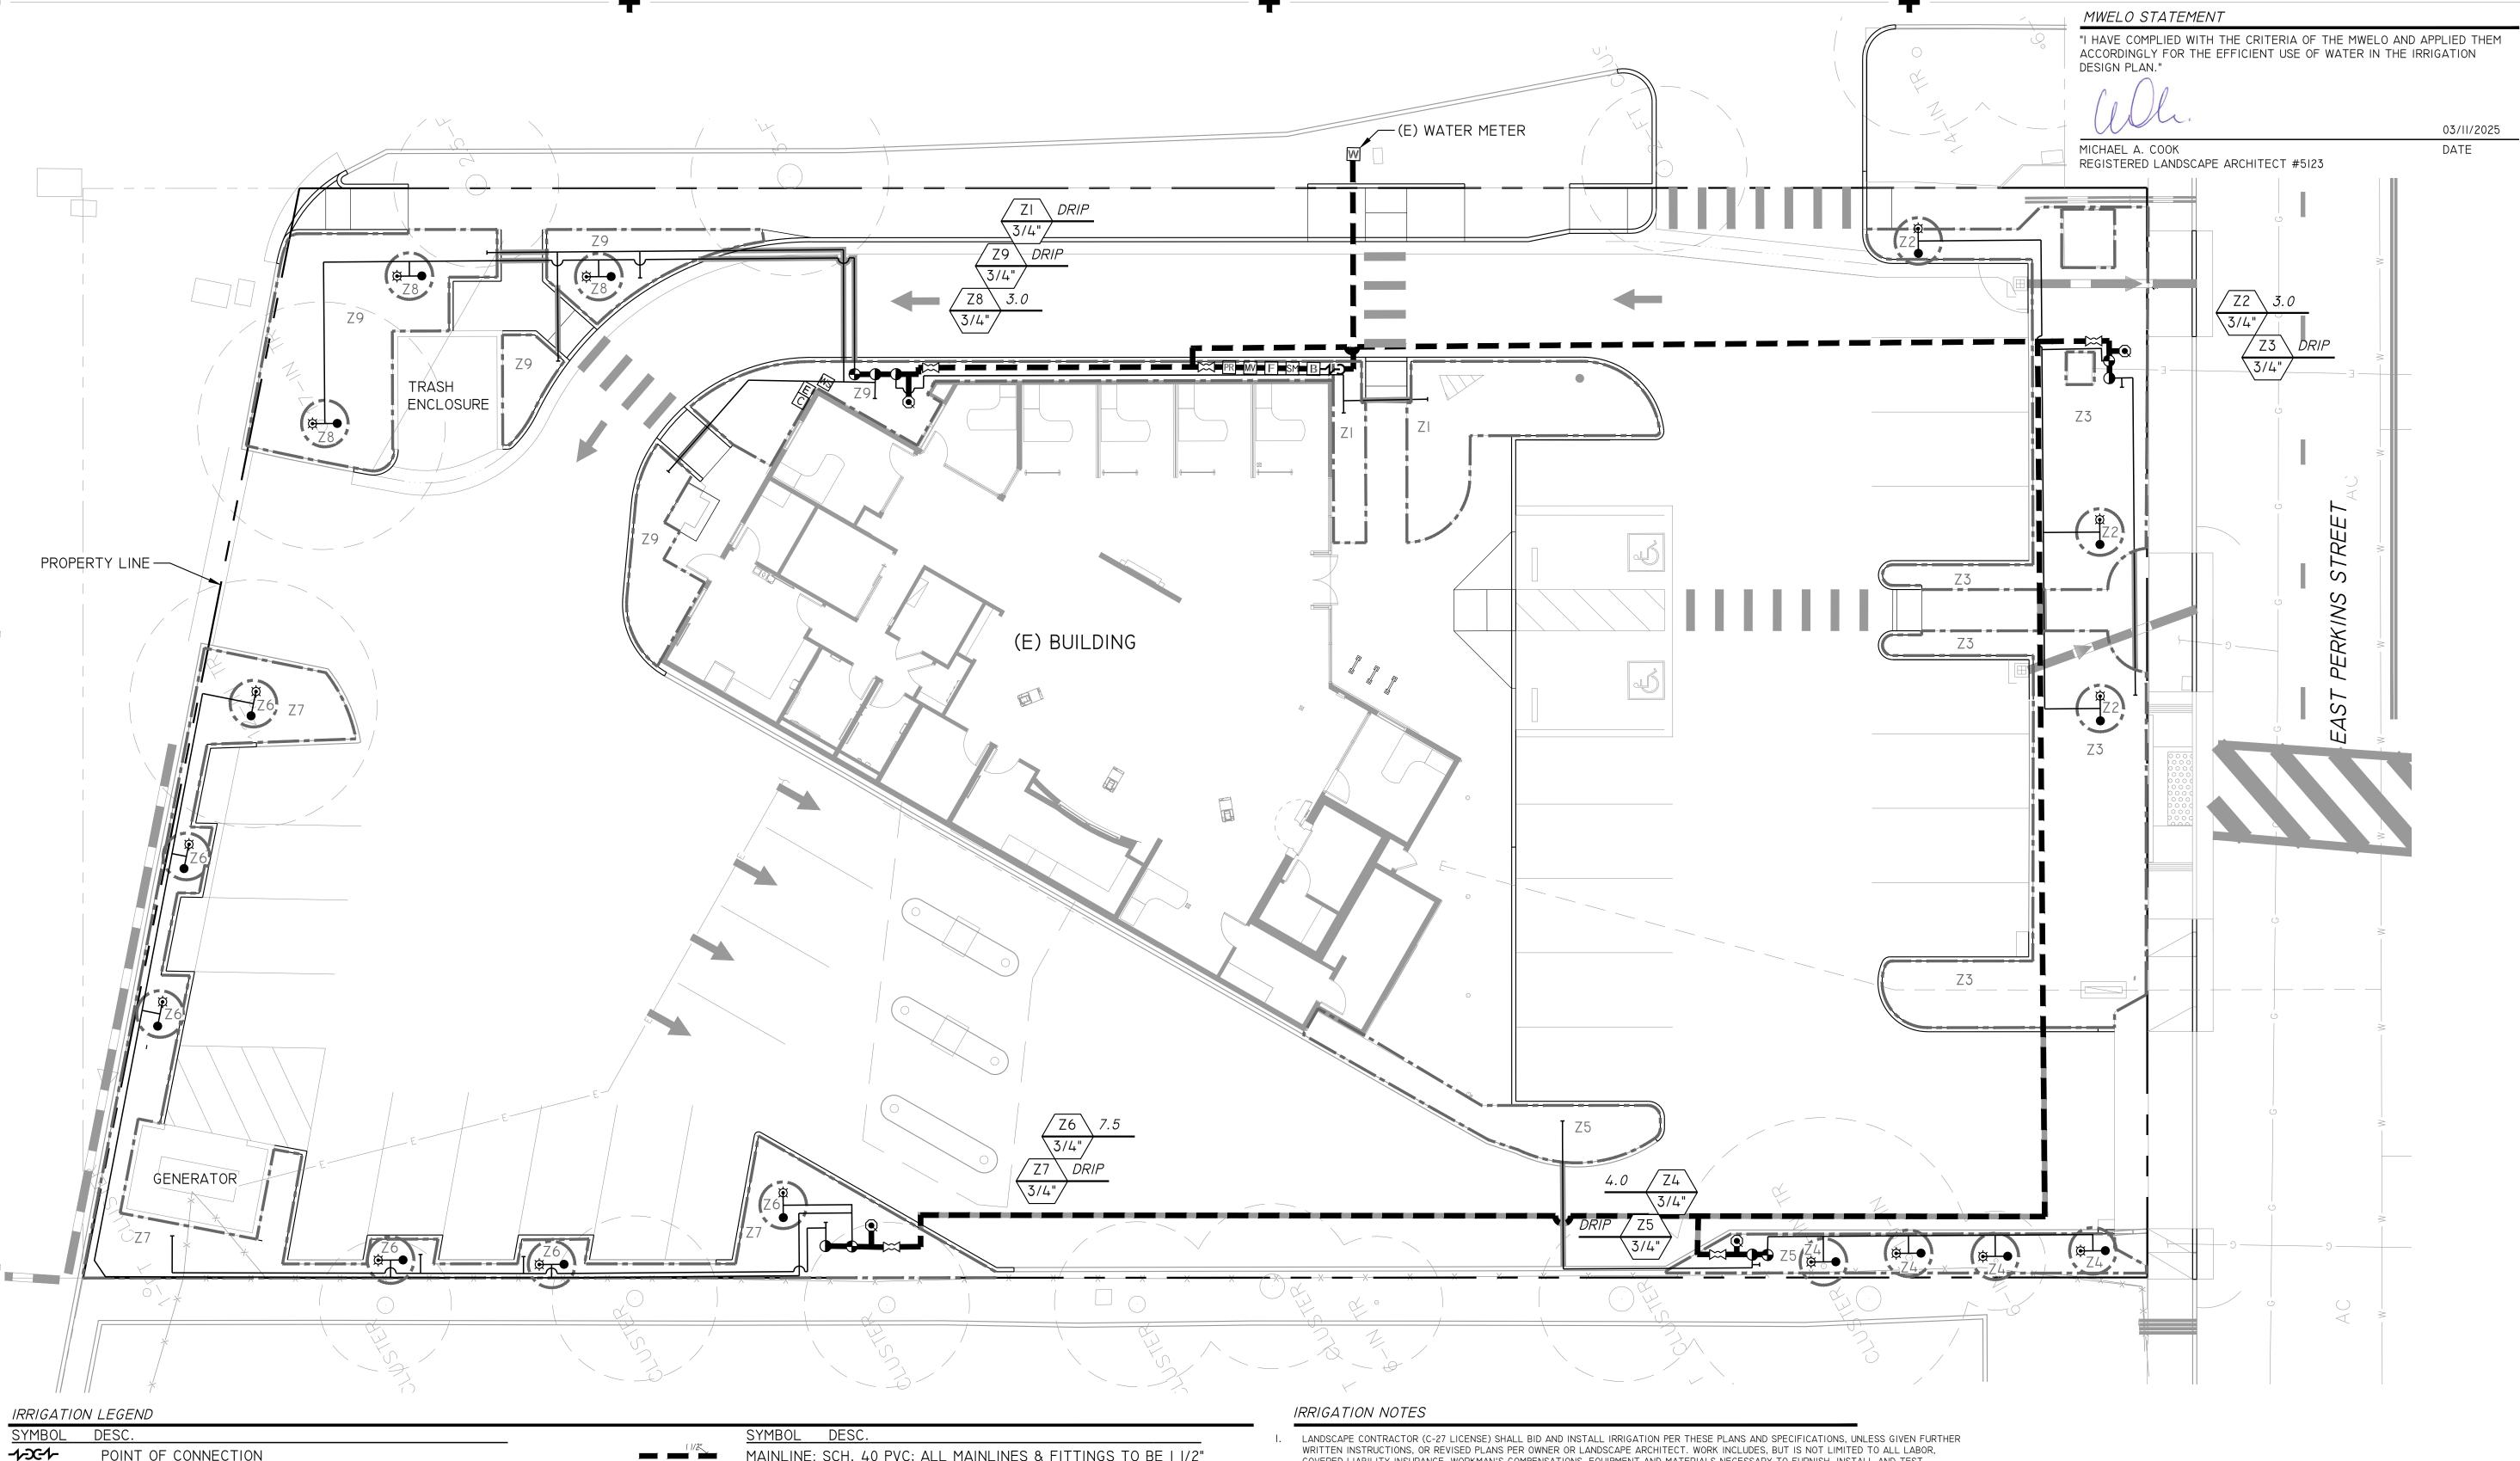

POINT OF CONNECTION

EXISTING WATER METER: (PER CITY/COUNTY STANDARDS)

SUB-METER: NETAFIM #WM-I00-0.I-ER-P, IRON, INSTALL AT POINT OF CONNECTION

BACKFLOW DEVICE (PER CITY/COUNTY STANDARDS)

FLOW SENSOR: IRRITROL FS-BIOO.

MASTER VALVE: SUPERIOR 3200, NORMALLY CLOSED (LINE SIZE).

PRESSURE REGULATOR: WATTS #LF-U5B Z3 2, SYSTEM SET TO 55 ELECTRICAL CONNECTION: SEE ELECTRICALDRAWINGS CONTROLLER: IRRITROL MCE-12E 12 STATION CONTROLLER, WALL

MOUNT IN LOCKABLE BOX

WEATHER SENSOR: IRRITROL CL-100-WIRELESS CLIMATE

LOGIC SENSOR. INSTALL ON ROOF GUTTER

BALL VALVE: NDS PVC BALL VALVE (LINE SIZE)

REMOTE CONTROL VALVE: TORO 700 SERIES. (SIZE AS SHOWN)

DRIP REMOTE CONTROL VALVE: TORO 700 SERIES W/DZK-700 DRIP KIT. (SIZE AS SHOWN)

QUICK COUPLER: RAINBIRD I" 44-NP W/LOCKING COVER.

MAINLINE: SCH. 40 PVC; ALL MAINLINES & FITTINGS TO BE I I/2" UNLESS OTHERWISE NOTED ON PLANS.

LATERAL LINE: SCH. 40 PVC; ALL LATERALS & FITTINGS TO BE 3/4" UNLESS OTHERWISE NOTED ON PLANS.

FLEXIBLE DRIP LINE:SCH. 40 PVC LATERAL & RISERS W/ 5/8" POLY DRIP TUBING & END CAPS (TUBING NOT SHOWN FOR CLARITY) STREAM BUBBLER: TORO #570Z-6P PRX COM W/SB-I80-PC2, SCH 40

PVC LATERALS AND RISERS. FLOOD BUBBLER: RAINBIRD 1404 WITH RWS-BC-1404; ADD SAND SOCK.

SLEEVES: SCH. 40 PVC; TWICE THE SIZE AS PIPING. HYDROZONE BOUNDARY

— VALVE NUMBER GALLONS PER MINUTE (G.P.M.) I" / <del>→</del> VALVE SIZE

COVERED LIABILITY INSURANCE, WORKMAN'S COMPENSATIONS, EQUIPMENT AND MATERIALS NECESSARY TO FURNISH, INSTALL AND TEST IRRIGATION SYSTEM, AS SHOWN ON THE DRAWINGS AND SPECIFIED HEREIN.

5. ALL IRRIGATION EQUIPMENT TO BE INSTALLED PER CITY, COUNTY AND STATE STANDARDS. THE CONTRACTOR SHALL OBTAIN AND PAY FOR ANY AND ALL PERMITS AND INSPECTIONS AS REQUIRED. THE MATERIAL AND WORK SHALL CONFORM TO ALL APPLICABLE PROVISIONS OF THE LATEST ADDITIONS OF THE UNIFORM PLUMBING CODE AND THE NATIONAL ELECTRIC CODE. CONTRACTOR SHALL FAMILIARIZE HIMSELF/HERSELF WITH ALL STATE AND LOCAL LAWS, CODES, ORDINANCES, RESTRICTIONS BEFORE BEGINNING INSTALLATION.

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9. THESE DRAWINGS INCLUDE A DIAGRAMMATIC DISPLAY THAT SHOWS:

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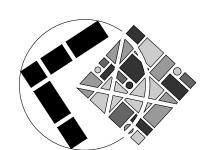
TRENCHING, AND OPTIMUM COVERAGE. OBTAIN WRITTEN APPROVAL FOR CHANGES PRIOR TO CONSTRUCTION. C. DRIP SYMBOL IS SCHEMATIC, VERIFY PLANT QUALITIES FOR EXACT NUMBER OF EMITTERS AND LENGTH OF PIPE. ALL OFFSET, FITTINGS,

SLEEVES, ETC. ARE NOT INDICATED DUE TO SCALE OF DRAWINGS, AND ARE TO BE FURNISHED AS REQUIRED. D. CONTRACTOR SHALL ASSUME ALL RESPONSIBILITY FOR WORK INSTALLED IN AREA WHERE WORK HAS BEEN MODIFIED WITHOUT WRITTEN

E. PIPE SIZES ON PLANS ARE MINIMUM ALLOWABLE.

### NOTES

REFER TO SHEET L2.I-L2.2 FOR IRRIGATION DETAILS & MWELO CALCULATIONS.



GRAPHIC SCALE (IN FEET) I INCH = 10 FT

🦫 🏖 P.L.A. 5123 🖔 11 / 30 / 2026 Renewal Date Michael A. Cook



PLA 5123 Exp. 11/30/2026

PLANNING+ LANDSCAPE

ARCHITECTURE

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PROJECT:

REDWOOD CREDIT 414 EAST PERKINS STREET UKIAH, CALIFORNIA, 95482 APN #002-200-32

CLIENT: AXIA ARCHITECTS


540 MENDOCINO AVENUE SANTA ROSA, CALIFORNIA, 95401


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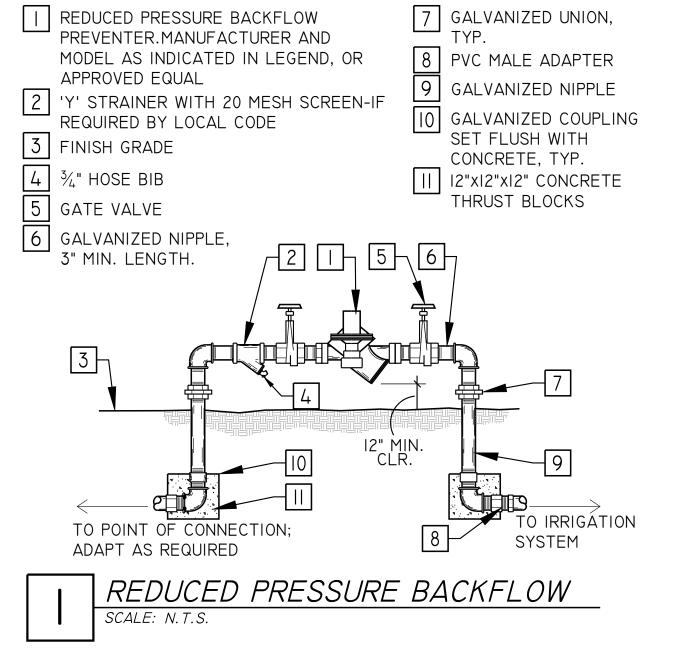
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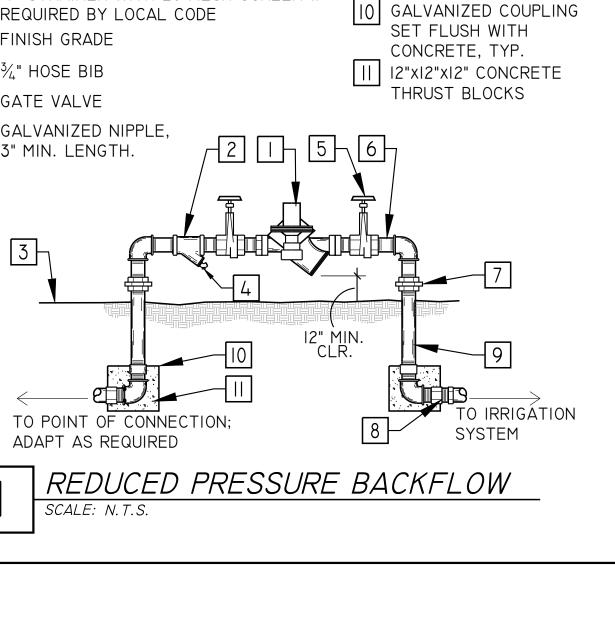
DATE: 03/11/2025 SCALE: l"=|0'=0" DRAWN BY: CHECKED BY: MAC


SHEET L2.0 of 7 NUMBER: PROJECT 24-057.02 NUMBER:






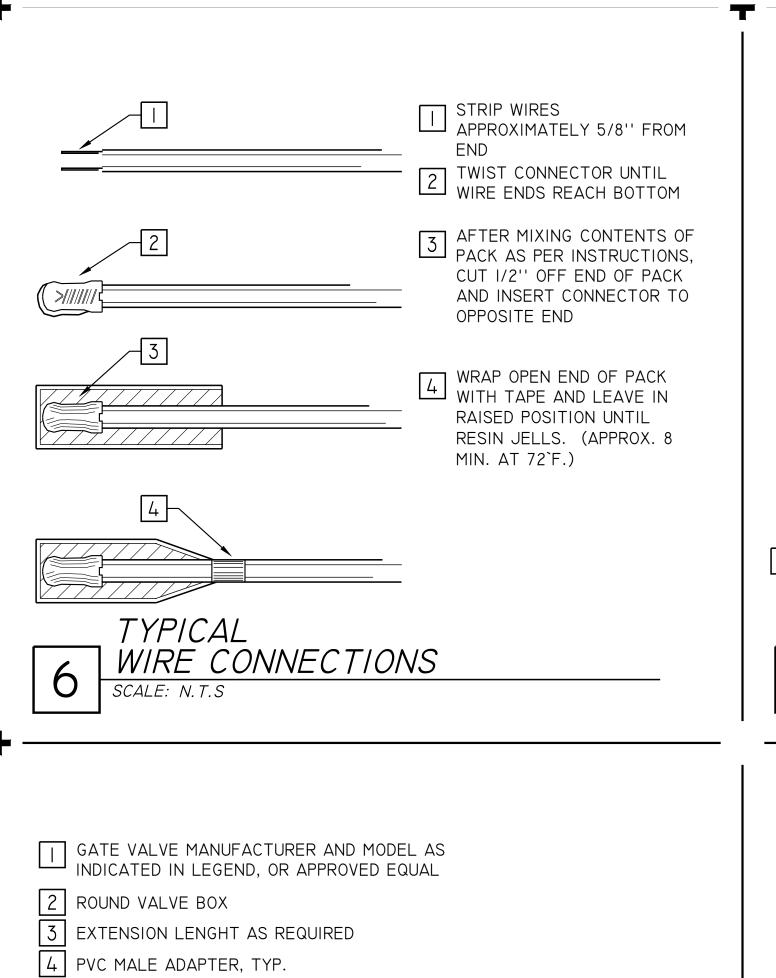

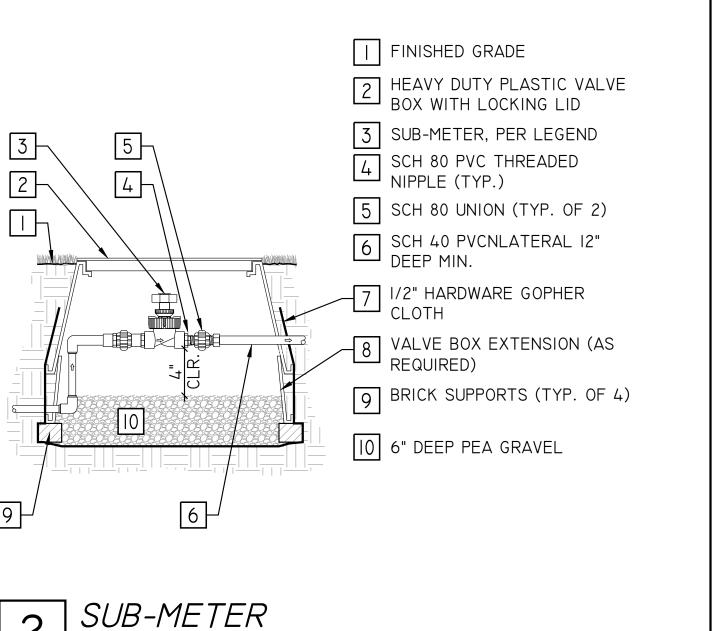

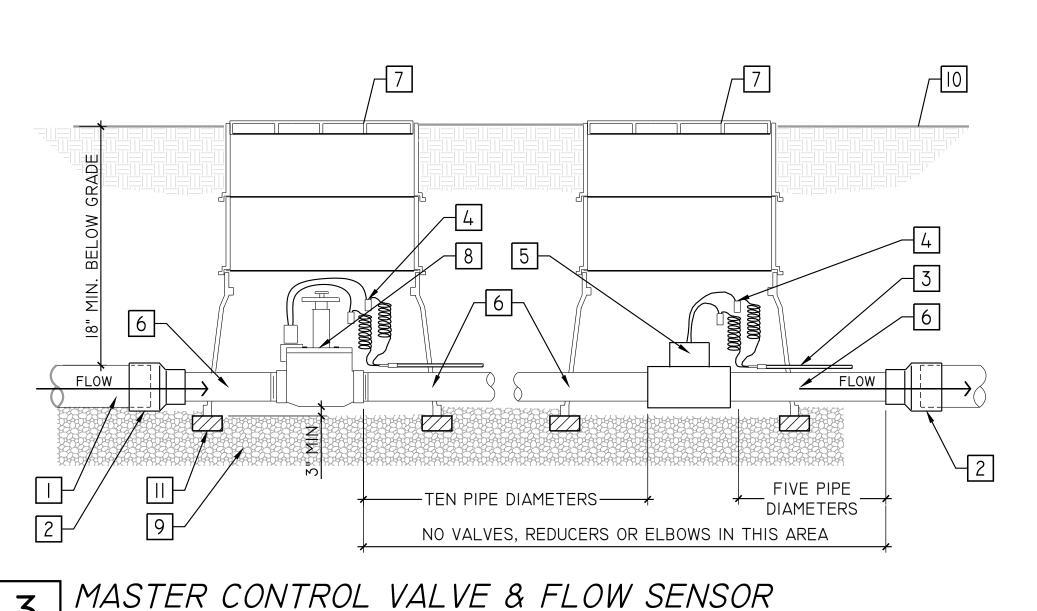

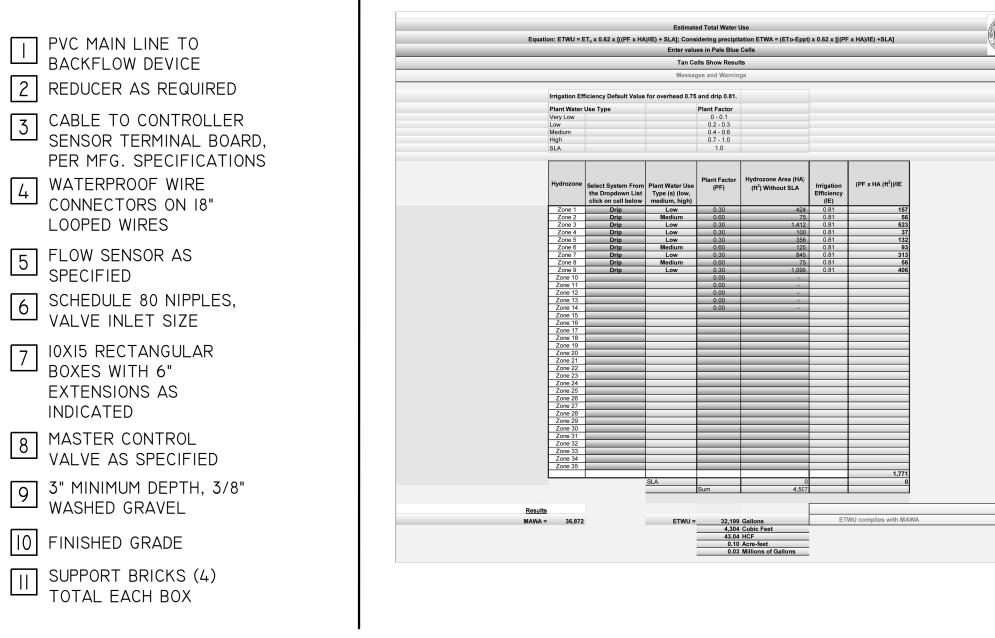

VALVE #I DRIP

VALVE #3 | DRIP

VALVE #5 DRIP

VALVE #7 DRIP

VALVE #9 DRIP

PLANT TYPE

LOW WATER USE MEDIUM WATER USE

HIGH WATER USE

Cells with pale blue background are for entering data

Messages and warnings are displayed in cells with yellow back 1) Select city by clicking on blue cell and

Results show in cells with tan background

hoosing a city from the drop down menu ET

VALVE #2 | BUBBLER

VALVE #4 | BUBBLER

VALVE #6 | BUBBLER

VALVE #8 BUBBLER

SUMMARY HYDROZONE TABLE: (CONTROLLER A)

TOTAL

AREA (SF) | % OF LANDSCAPE

4,507

(ET<sub>o</sub>) x (0.62) x [(0.45 x LA) + (1.0 - 0.45) X SLA)]

6.1%

Tan Cells Show Results

0 Overhead Landscape Area (ft²)

4507 Drip Landscape Area (ft²)

0 SLA (ft²)


Cubic Feet

4,507 LA (ft<sup>2</sup>)

4,929.05 Cubic Feet 49.29 HCF 0.11 Acre-feet

0 SLA (ft<sup>2</sup>)

100.0%

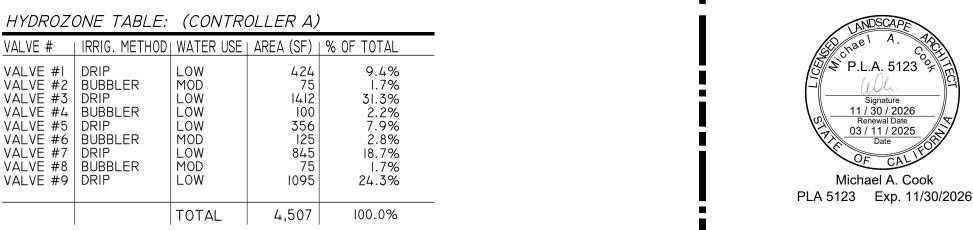



# PLANNING+ LANDSCAPE ARCHITECTURE

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*PROJECT:* 

## REDWOOD CREDIT

414 EAST PERKINS STREET UKIAH, CALIFORNIA, 95482 APN #002-200-32

CLIENT:

AXIA ARCHITECTS

540 MENDOCINO AVENUE SANTA ROSA, CALIFORNIA, 95401

MWELO CALCS.

SHEET DESCRIPTION: IRRIGATION DETAILS,

REVISIONS:

DATE:	03/11/2025
SCALE:	AS SHOWN
DRAWN BY:	MG
CHECKED BY:	MAC

SHEET L2.1 of 7 NUMBER : PROJECT 24-057.02 NUMBER:

I. PILOT WIRES SHALL BE A DIFFERENT COLOR FOR EACH VALVE. COMMON WIRES SHALL BE WHITE WITH A DIFFERENT COLOR STRIPE FRO EACH AUTOMATIC CONTROLLER. 2. NO SPLICES SHALL BE MADE BETWEEN CONTROLLER AND REMOTE CONTROL VALVE UNDER

5 FINISHED GRADE

6 SUPPORT BRICKS (4) TOTAL

3/4" WASHED CRUSHED


AGGREGATE BASE OR PEA GRAVEL

GATE VALVE

SCALE: N.T.S.

NOTES:

500 LINEAL FEET. 3. CONTROL WIRING SEQUENCE CORRESPONDS TO OPERATING SEQUENCE OF REMOTE CONTROL VALVES AND AUTOMATIC SPRINKLER CONTROL UNIT STATION CONNECTION SEQUENCE. SEQUENCE SHOWN ON DETAIL IS FOR REFERENCE ONLY-SEE IRRIGATION PLAN FOR CORRECT VALVE SEQUENCE.

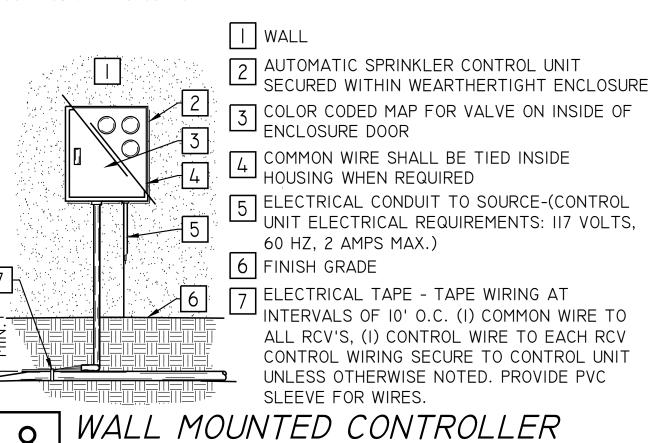

NOTES:

I. ALL SLEEVES TO BE SCHEDULE 40 PVC.

2. EXTEND ALL SLEEVES 12" BEYOND EDGE OF HARDSCAPING AT BOTH ENDS.

3. 24" MINIMUM COVER ON MAINLINE 3" AND LARGER

CLEAN BACKFILL- 90% COMPACTION REQUIRED 2 HARDSCAPE/PAVING 3 NON-PRESSURE LATERAL LINE SLEEVE SIZE TWICE DIAMETER OF NON-PRESSURE LATERAL LINE

4 SAND 5 PRESSURE SUPPLY LINE SLEEVE- SIZE TWICE DIA. OF PRESSURE SUPPLY LINE

6 CONTROL WIRE SLEEVE-SIZE PER PLAN. INSTALL ADJACENT TO PRESSURE SUPPLY LINE


TYPICAL SLEEVING


I. PIGTAIL AND LOOP CONTROL WIRE AT ALL 90° CHANGES IN DIRECTION. 2. PROVIDE A MINIMUM IO FEET SEPARATION BETWEEN POTABLE AND


RECLAIMED MAINLINE PIPING. 3. 24" MINIMUM COVER ON 3" MAINLINE AND LARGER.

CLEAN BACKFILL-90% COMPACTION REQUIRED 2 FINISH GRADE 3 NON-PRESSURE LATERAL LINE SNAKE PIPE IN TRENCH PRESSURE
SUPPLY LINE
SNAKE PIPE IN TRENCH 5 CONTROL WIRES-BUNDLE AND TAPE AT 10' O.C. AND INSTALL ADJACENT TO PRESSURE SUPPLY LINE 6 PROVIDE 2" MIN. OF CLEAN BACKFILL


TYPICAL TRENCHING SCALE: N.T.S

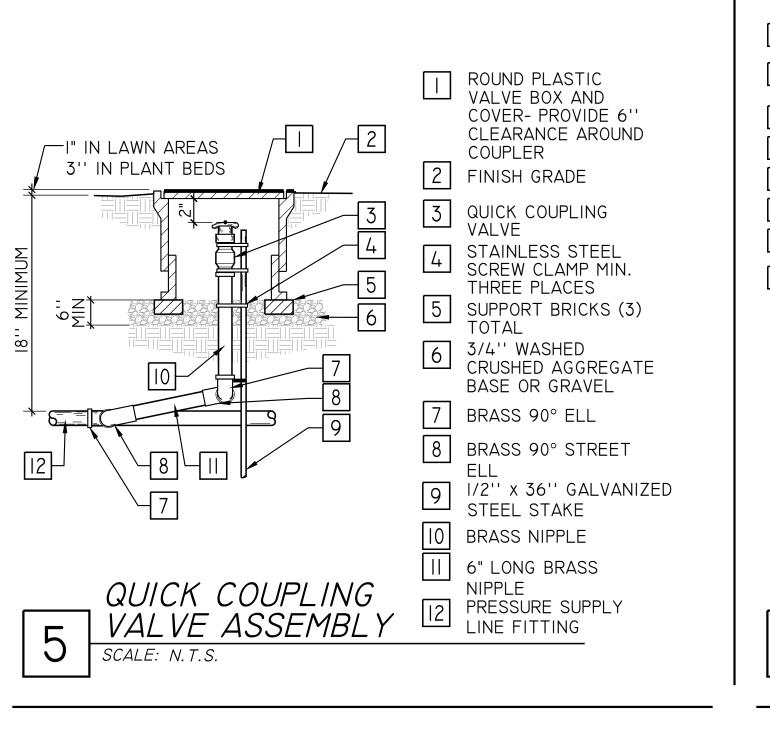

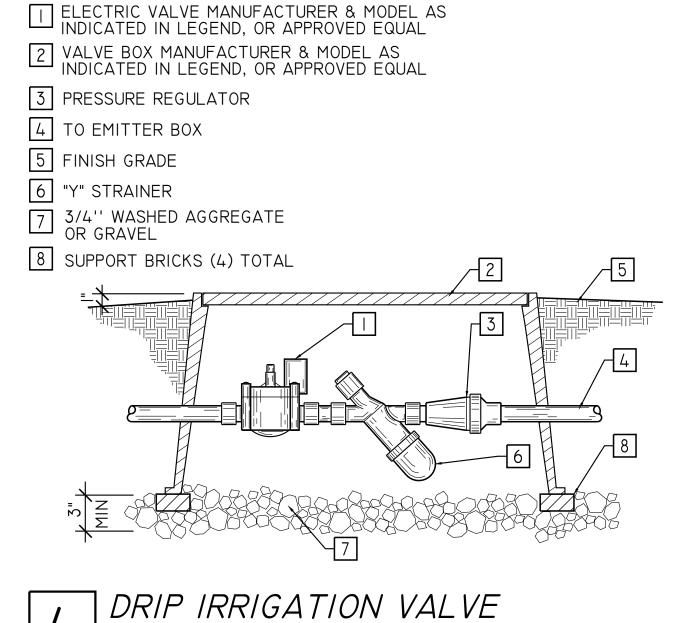

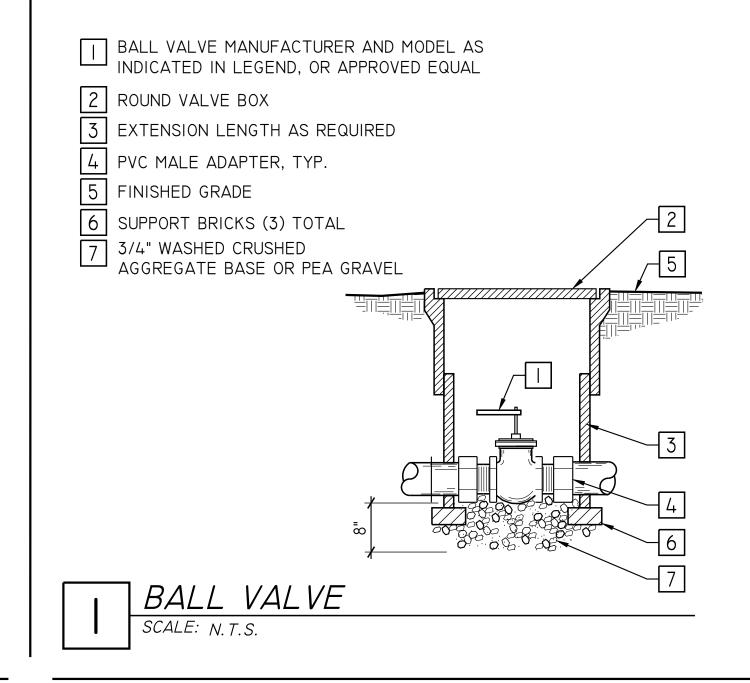



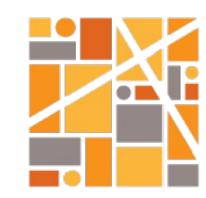

PLANNING+ LANDSCAPE ARCHITECTURE

1506 4TH STREET SANTA ROSA. CALIFORNIA 95404 707.852.0500 WWW.INTEGRAPLA.COM INTEGRA IS NOT RESPONSIBLE FOR THE ACCURACY OR COMPLETENESS OF REPRODUCTIONS OF THIS DOCUMEN' GENERATED BY OTHERS FROM ELECTRONIC MEDIA.

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PROJECT:

# REDWOOD CREDIT

414 EAST PERKINS STREET UKIAH, CALIFORNIA, 95482 APN #002-200-32

CLIENT:


AXIA ARCHITECTS

540 MENDOCINO AVENUE SANTA ROSA, CALIFORNIA, 95401

SHEET DESCRIPTION:

REVISIONS:

IRRIGATION DETAILS

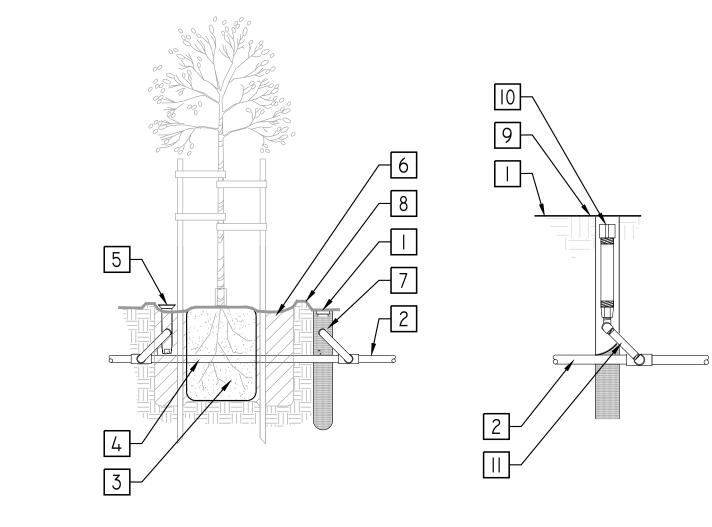

TREE DEEP ROOT WATERING

### NOTES:

- I. INSTALL PRODUCT SO THAT THE LID IS EVEN WITH FINISH GRADE OR TOP
- 2. WHEN INSTALLING IN EXTREMELY HARD OR CLAY SOILS, ADD 3/4" GRAVEL UNDER AND AROUND THE UNIT TO ALLOW FASTER WATER INFILTRATION AND ROOT PENETRATION.
- 3. ONCE PRODUCT HAS BEEN INSTALLED FILL THE BASKET WITH PEA GRAVEL BEFORE LOCKING LID.
  - | | FINISH GRADE 2 PVC LATERAL LINE
    - 7 SAND SOCK OUTSIDE
  - 3 ROOTBALL
- 4 ROUTE LATERAL LINE AROUND ROOT BALL AT EDGE OF PLANTING PIT

SCALE: N.T.S.

5 PLACE POP-UP STREAM BUBBLER AT EDGE OF ROOTBALL INSIDE BERM 6 PLACE POP-UP FLOOD BUBBLER AT EDGE OF

ROOTBALL INSIDE BERM

- BASIN FURTHEST AWAY FROM CURB OR HIGH SIDE OF SLOPE
- 8 2" BERM AT EDGE OF PLANTING PIT TO FORM BASIN 9 PLACE FIRM SOIL IMMEDIATELY AROUND TUBE
- 10 FLOOD BUBBLER IN FIXED RISER
- LOW DENSITY PIPE OR POLYETHTLENE PIPE 14" MIN. / 24" MAX.





I. CENTER VALVE BOX OVER REMOTE CONTROL VALVE TO FACILITATE SERVICING VALVE.

GROUND-COVER/SHRUB AREA AND FLUSH WITH FINISH GRADE IN TURF AREA.

PLAN VIEW

2. SET BOXES I" ABOVE FINISH GRADE OR MULCH COVER IN

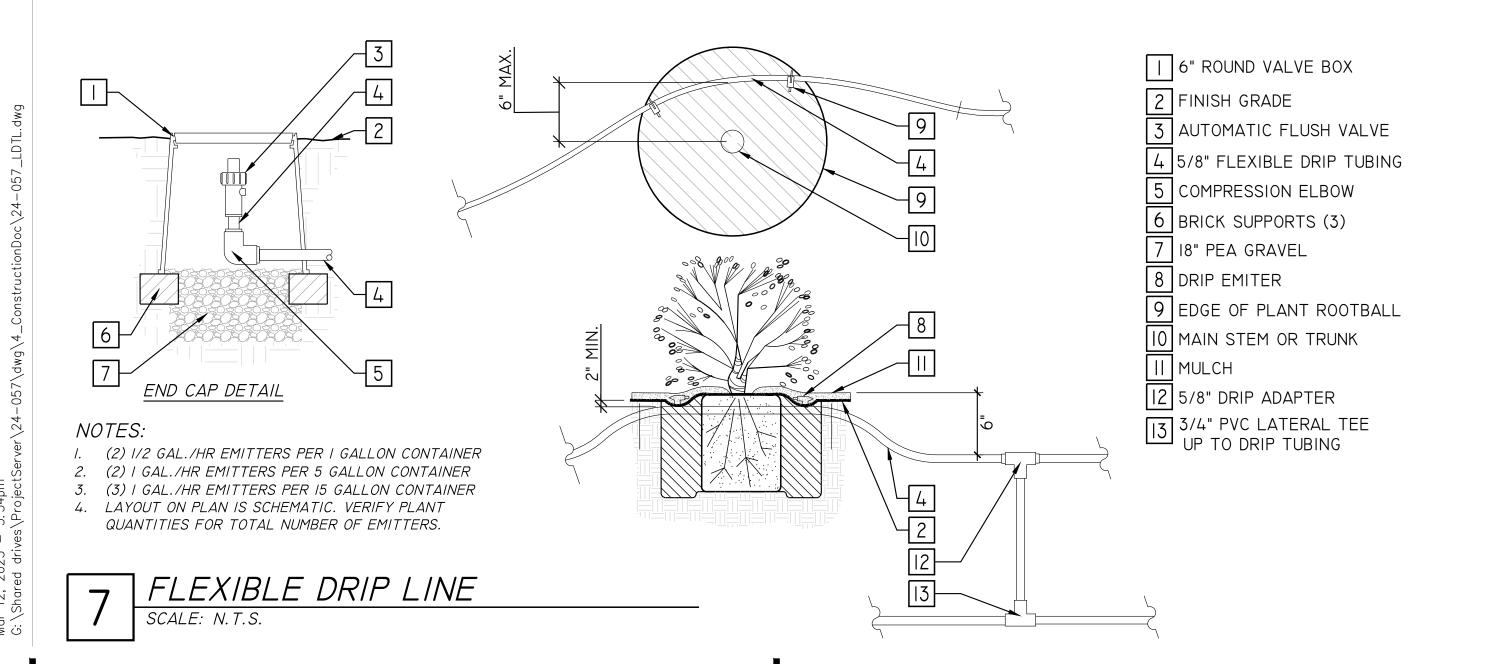

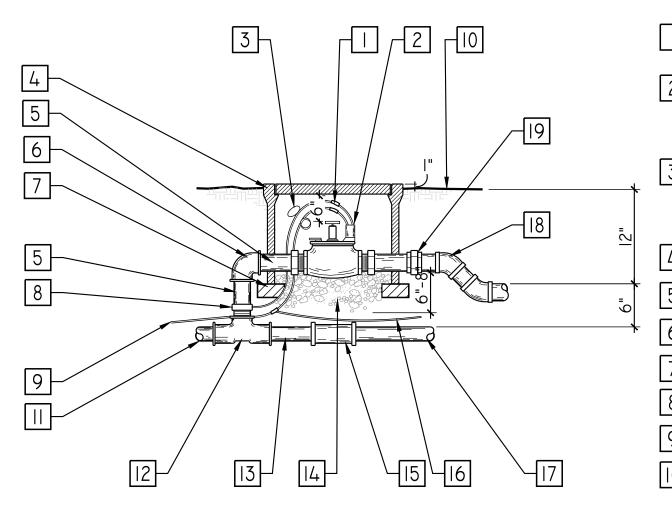

APPROVED WATERPROOF WIRE CONNECTORS (TYPICAL)

SCALE: N.T.S

NOTES:

2 ELECTRIC CONTROL VALVE MANUFACTURER AND MODEL AS INDICATED IN LEGEND, OR APPROVED EQUAL.

3 LOOP THIRTY-SIX (36) INCHES EXCESS WIRE INTO EACH SINGLE BOX AND INTO ONE VALVE BOX IN EACH GROUP OF VALVES.

4 VALVE BOX

5 PVC SCH. 80 PIPE

6 PVC SXS 90 ELL

7 SUPPORT BRICKS (4) TOTAL 8 PVC TXS MALE ADAPTER (TYPICAL)

9 CONTROL WIRES TO CONTROLLER

10 FINISH GRADE

MAINLINE TO COUPLING

12 LINE SIZED PVC TEE TO COMPRESSION COUPLING 13 MAINLINE

14 3/4" WASHED AGGREGATE OR GRAVEL

TEACH END LOCATE AT EACH END. LOCATE COUPLING UP AND DOWN STREAM OF PVC TEE

EDGE OF LAWN,

└┴┘ WALK, FENCE,

23"x33" RECTANGULAR

3 |4"X|9"

CURB, ETC.

VALVE BOX

RECTANGULAR VALVE BOX

TYPICAL QUICK COUPLING VALVE

[6] COMMON WIRES TO VALVES ON SAME CONTROLLER


17 EXISTING MAINLINE

18 LOWER LATERAL LINE WITH 40 PVC 45° ELBOWS 9 SCH. 80 PVC UNION

03/11/2025 DATE: AS SHOWN SCALE: DRAWN BY: MG CHECKED BY: MAC

> SHEET L2.2 of 7 NUMBER : PROJECT 24-057.02 NUMBER:

REMOTE CONTROL VALVE ASSEMBLY SCALE: N.T.S

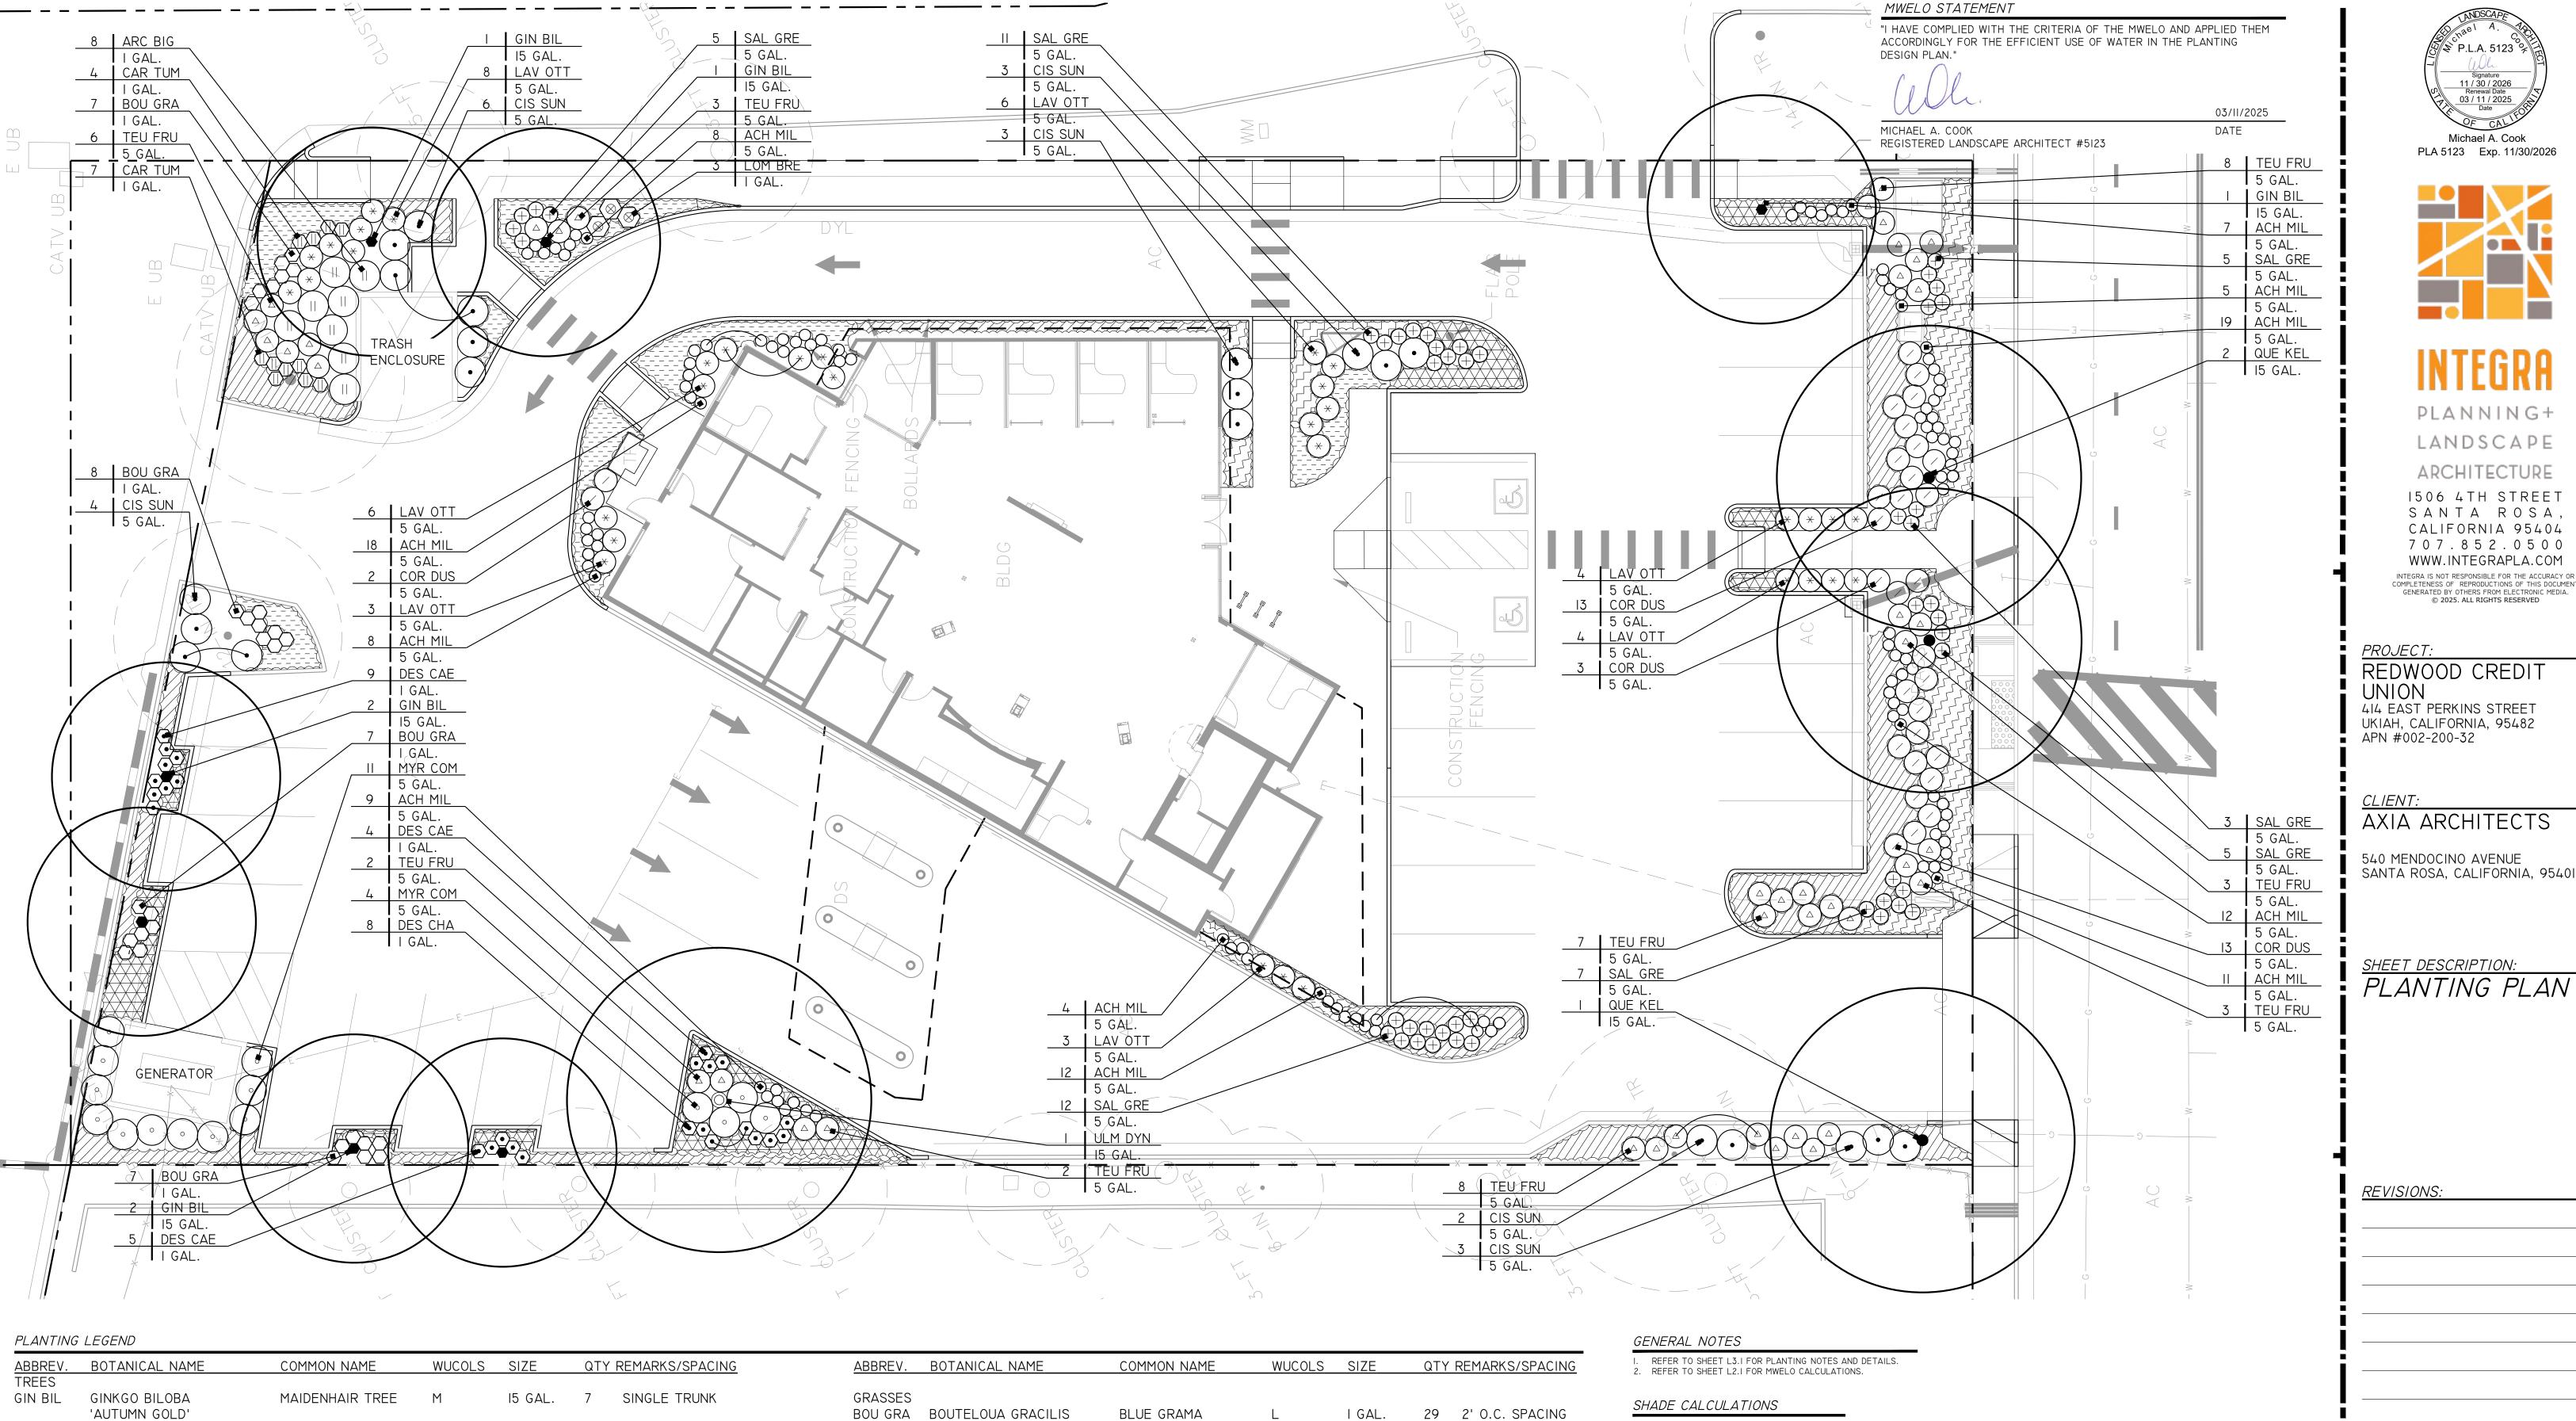

FOOTHILL SEDGE

MANZANITA

CEANOTHUS

CAL. FUSCHIA

PINK MYOPORUM

TUFTED HAIRGRASS

DWARF MAT GRASS

I GAL.

II 2' O.C. SPACING

26 2' O.C. SPACING

3 3' O.C. SPACING

- 4' O.C. SPACING

- 5' O.C. SPACING

- 3' O.C. SPACING

I GAL. - 6' O.C. SPACING

CAR TUM CAREX TUMULICOLA

GROUNDCOVER

DES CAE DESCHAMPSIA CESPITOSA

ARCTOSTAPHYLOS

'EMERALD CARPET'

EPILOBIUM CANUM


MYOPORUM P. 'PINK'

CEANOTHUS 'CENTENNIAL'


LOM BRE LOMANDRA L. 'BREEZE'

10,879 SQ. FEET PARKING LOT AREA: TREE CANOPY SHADE AREA: 7,029 SQ. FEET

PERCENTAGE COVERAGE: 64.6 %

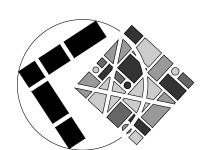

GRAPHIC SCALE (IN FEET) I INCH = 10 FT

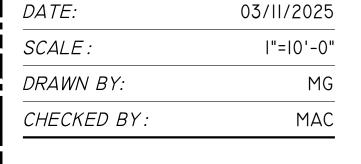

F.L.A. 5123 9

Signature
11 / 30 / 2026
Renewal Date
03 / 11 / 2025
Date

Michael A. Cook

PLA 5123 Exp. 11/30/2026

PLANNING+

LANDSCAPE

ARCHITECTURE

1506 4TH STREET

SANTA ROSA

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SHEET L3.0 of 7 NUMBER : PROJECT 24-057.02 NUMBER:

ULM DYN ULMUS 'DYNASTY'

SHRUBS

SAL GRE

QUE KEL QUERCUS KELLOGGII

ACH MIL ACHILLEA MILLEFOLIUM

'SENTINEL

MYR COM MYRTUS C. 'COMPACTA'

TEU FRU TEUCRIUM FRUTICANS

SALVIA GREGGII

CIS SUN CISTUS X P. 'SUNSET'

ARCTOSTAPHYLOS

CORREA 'DUSKY BELLS'

CHINESE ELM

BLACK OAK

YARROW

LAVANDULA S. 'OTTO QUAST' SPANISH LAVENDER L

MANZANITA

SUNSET ROCKROSE

DWARF MYRTLE

AUTUMN SAGE

AUSTRALIAN FUCHSIA L

BUSH GERMANDER L

I5 GAL.

I5 GAL.

5 GAL.

5 GAL.

5 GAL.

5 GAL.

SINGLE TRUNK

SINGLE TRUNK

113 18" O.C. SPACING

8 4' O.C. SPACING

21 4' O.C. SPACING


34 3' O.C. SPACING

15 4' O.C. SPACING

48 2' O.C. SPACING

42 3' O.C. SPACING

3' O.C. SPACING

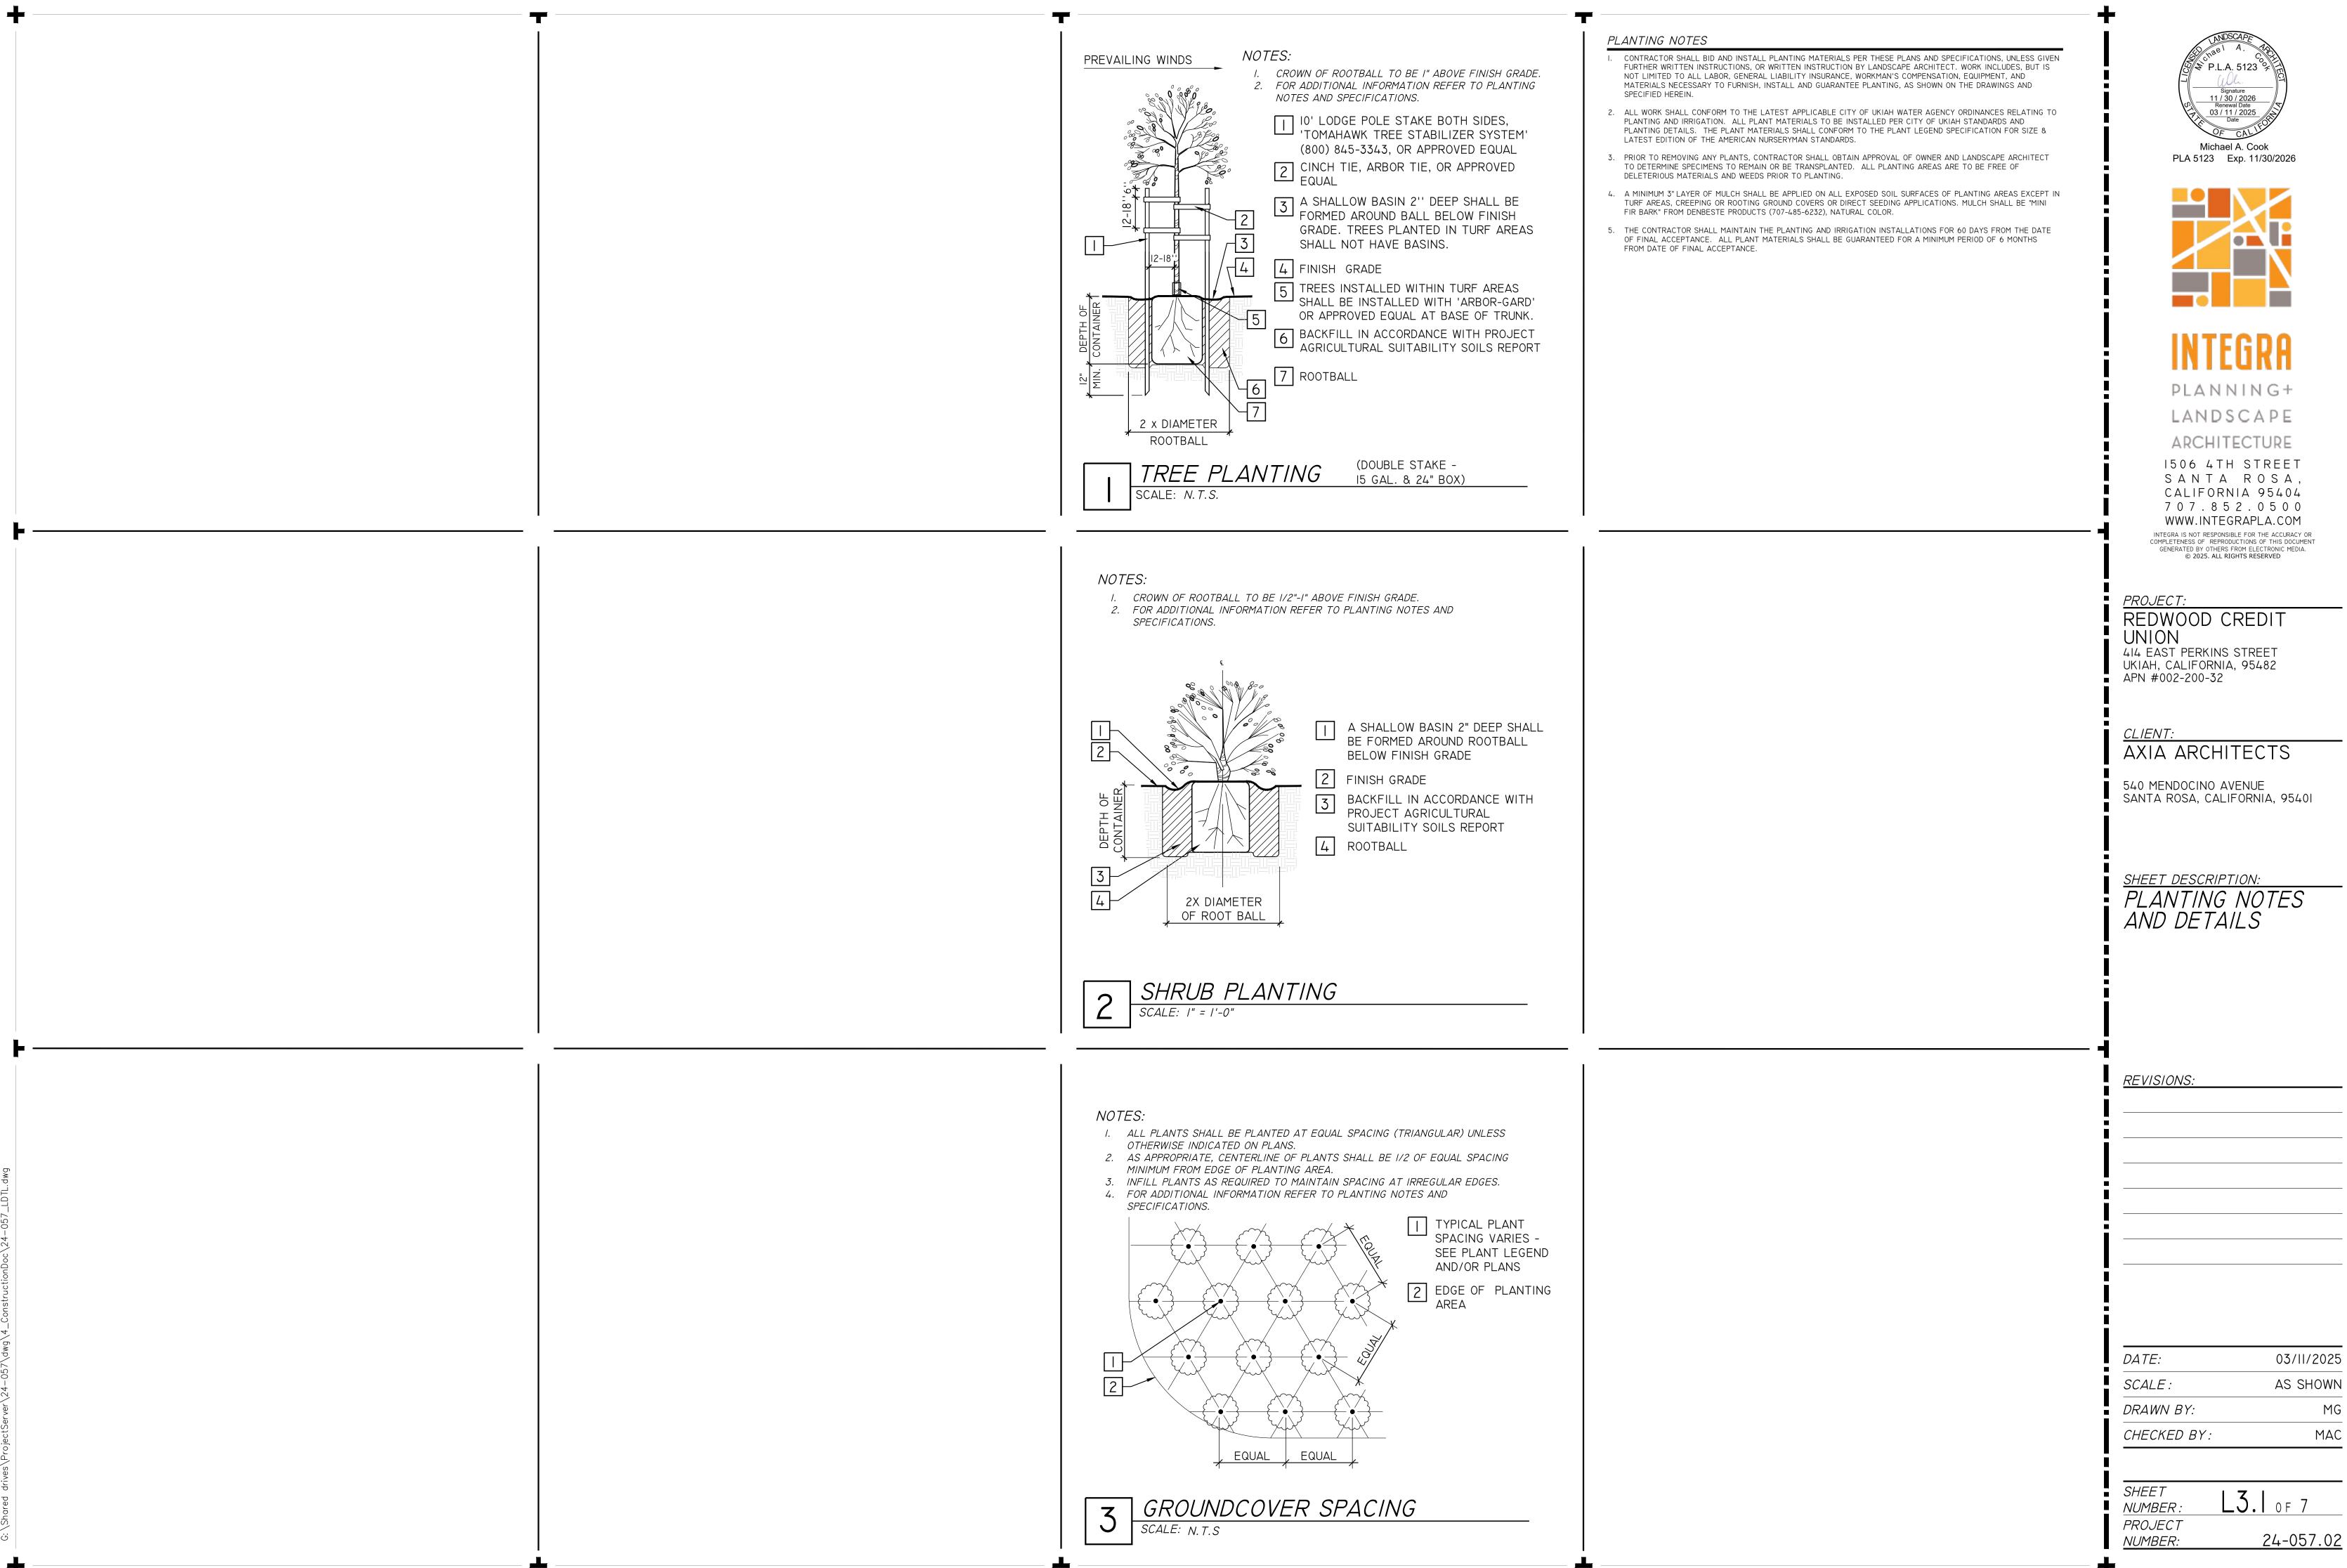

2025 — 3:34pm